

NORTH SYDNEY COUNCIL REPORTS

## NSLPP MEETING HELD ON 03/04/24 SECTION 4.56 APPLICATION REPORT

# Attachments: 1. Site Plan 2. DA86/2022 Approved Elevations and Floor Plans 3. Development Consent No. 86/22/2 4. Council correspondence concerning Conditions C50, C51 and C52 5. Architectural Plans 6. Design Report

ADDRESS: 96-98 Ben Boyd Road, Neutral Bay

**APPLICATION No:** DA 86/2022/03

**PROPOSAL:**Modification of Court Approved residential flat building (DA86/22)<br/>to provide for an amended balcony design to the southern and<br/>western elevations of an approved residential flat building and<br/>satisfy the intent of Condition C51 Balconies – Design<br/>Amendments

#### PLANS REF:

Plan Nos.	Rev	Description	Prepared by	Dated
DA 1002	Н	Site Plan	MHNDUNION	15/02/24
DA 2002	Н	Ground Floor Plan	MHNDUNION	14/12/23
DA 2003	н	Level 1 Floor Plan	MHNDUNION	14/12/23
DA 2004	н	Level 2 Floor Plan	MHNDUNION	14/12/23
DA 2005	Н	Level 3 Floor Plan	MHNDUNION	14/12/23
DA 2006	Н	Level 4 Floor Plan	MHNDUNION	14/12/23
DA 2007	Н	Level 5 Floor Plan	MHNDUNION	14/12/23
DA 3001	Н	Elevation South	MHNDUNION	14/12/23
DA 3003	Н	Elevation West	MHNDUNION	15/02/24
DA 9103	Н	Site Coverage Diagram	MHNDUNION	15/02/24

OWNER:	Aidop No 3 Pty Ltd
APPLICANT:	The Trustee for Aidop No 3 Unit Trust
AUTHOR:	Thomas Holman, Senior Assessment Officer
DATE OF REPORT:	7 March 2024
DATE LODGED:	12 February 2024
<b>RECOMMENDATION</b> :	Approval

# **EXECUTIVE SUMMARY**

Development Application DA86/2022 for demolition of existing structures and construction of a residential flat building containing 21 apartments including basement parking and associated landscaping and civil works was approved by the Land and Environment Court on 30 November 2022.

The previous modification application (DA 86/22/2 - MOD 1) was determined by the North Sydney Local Planning Panel (NSLPP) on 4 October 2023. Amended conditions were endorsed by the Panel which included changes to Condition C51 by the Panel to require the design of the approved balconies to match the LEC Court approved design and layout of the balconies to the southern elevation. The effect of the condition was to require a break in the form of the balconies and ensure appropriate built form and articulation.

The application is referred to the North Sydney Local Planning Panel for Determination as the terms of Condition C51 have not been satisfied in full and the applicant has submitted an alternative design which seeks to address the intent of the condition.

In accordance with the Ministerial Directions for Local Planning Panels an application for modification under the provisions of s4.56 of the Act which involves changes to a condition imposed by the Panel, must be determined by the Panel.


The proposal seeks to modify the terms of Condition C51 to provide for an amended balcony design that encompasses a physical break in the built form as well as provide additional building articulation. The proposed amended design differs from the LEC Court approved design and that currently required by Condition C51.

The proposed plans with amendments to the southern balconies and the Level 5 western balcony however satisfy the intent of Condition C51 Balconies – Design Amendments and would result in an improved design outcome over the previously proposed design under DA 86/22/2 – MOD 1.

The modifications do not result in any material adverse amenity impact to adjoining properties or the surrounding area and no submissions have been received following notification of the modification application.

Having regard to the provisions of section 4.56 & 4.15(1) of the Environmental Planning and Assessment Act 1979, the proposed development as modified is substantially the same development as originally consented to. The application is therefore recommended for **approval**.

## LOCATION MAP

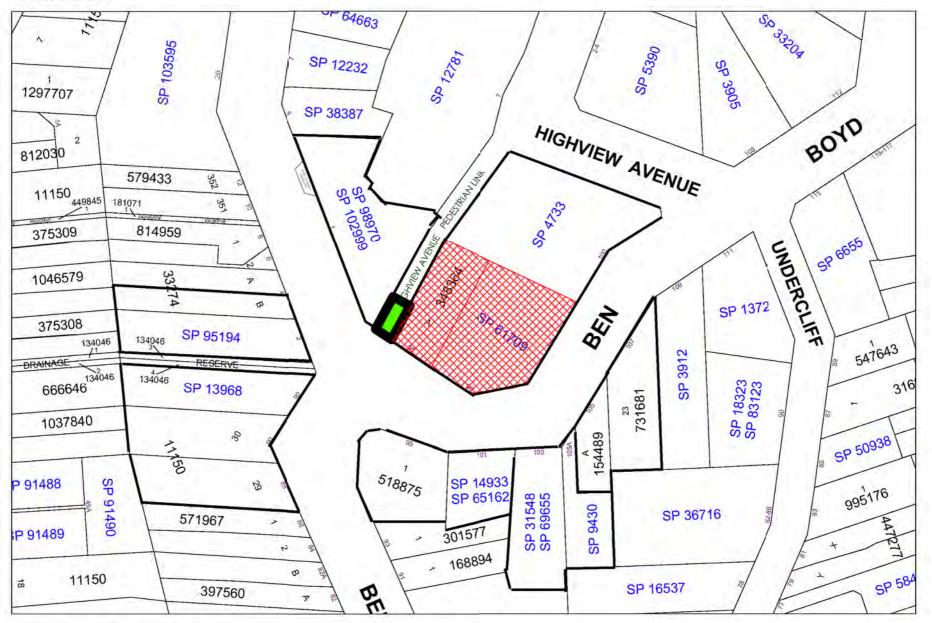

#### **DESCRIPTION OF PROPOSAL**

The proposal seeks to modify DA 86/22/2 to remove the requirements for the updated balcony design and delete the below condition of consent (*in italics*). The reason for deletion of the condition of consent is subject to amended plans proposing alterations to the design and size of the balconies on the southern elevation and Level 5 on the western elevation which seek to satisfy the intentions of the below condition although not strictly reverting to the balcony design approved under DA 86/22 – LEC No. 2022/165233.

Condition C51 states:

## **Balconies – Design Amendments**

**C51.** The southern balcony that serves Units 102 & 103 on Level 1, Units 202 & 203 on Level 2, Units 302 & 303 on Level 3, Unit 402 on Level 4 and Unit 502 on Level 5 is to be amended so not to be a continuous balcony but encompass a break in form as per that approved under DA 86/22 – LEC No. 2022/165233. The balconies subject to design amendments are clouded in red on the approved plans in A7 of this modification application consent.

The Level 5 balcony on the western side of the building (Unit 501) is not approved and shall remain as per the balcony approved under determination for DA 86/22 – LEC No. 2022/165233. The respective balcony subject to design amendments is clouded in red on Level 5 Floor Plan, DA 2007 Rev F.

The floor plans (Levels 1-5) and elevations must be submitted to Council for the written approval of Council's Manager Development Services prior to the issue of any construction certificate.

(Reason: To ensure control in site density, maintenance in articulation in built form to the streetscape and minimise additional exceedance in site coverage)

The previous modification application (DA 86/22/2) was granted consent by the North Sydney Local Planning Panel (NSLPP) on 4 October 2023 and the Council Officer's Report, Recommendation and amended conditions were endorsed subject to the above condition which was amended by the Panel.

The current modification application requires amendments to a condition of development consent recommended in the council assessment report, but which was amended by the panel. The ministerial Local Planning Panels direction for modification of consents requires that this application be deferred to the Panel for determination.

#### DESCRIPTION OF LOCALITY

The subject site is located at No. 96-98 Ben Boyd Road, Neutral Bay and comprises two (2) lots, being Lot A DP 348364 and SP 61709. The site is located on the northern side of Ben Boyd Road between the intersections with Premier Street and Highview Lane/Ben Boyd Road.

The site is an irregular shape and has its southern and eastern boundaries adjoining the road reserve of Ben Boyd Road and the western boundary adjoining Highview Lane. The total site area is 1,699.3m<sup>2</sup> as stipulated in the Survey Plan prepared by LTS Lockley dated 03 November 2021.



Figure 1 – Aerial photo of site (boundary in red) and surrounds

The site has a moderate and consistent slope down from the northern boundary towards the south which affords views and outlooks towards Neutral Bay and beyond to Sydney Harbour and the CBD.

The site is zoned R4 High Density Residential, subject to a maximum height control of 12m, not within a conservation area but in the vicinity of a local heritage item (I0574 - 107 Ben Boyd Road).



Figures 2, 3 & 4 – Land Zoning Map (left), Height of Building Map (middle) and Heritage Map (right) with subject site hatched in red

The existing site comprises of a two storey dwelling (No.96) and a four storey residential flat building (No.98). Adjoining the site to the west is Highview Lane and to the west of the lane is a five-storey residential flat building. Adjoining the site to the north is a nine-storey residential flat building with at-grade parking beneath the building. Properties to the western side of Premier Street are in Zone R2 Low Density Residential. Land to the southern side of Ben Boyd Road is in Zone R3 Medium Density Residential. Land to the north is within Zone R4 High Density Residential.



Figures 5, 6 & 7 – Photos of the site from the eastern side of Ben Boyd Road (left and middle), photo of site from southern side of Ben Boyd Road (right)

## **CHECKING OF PLANS**

This application has been checked to ensure that the changes being sought are the only changes included in the submitted plans. The changes sought are only to southern elevation balconies on Levels 1 - 5 and the western elevation Level 5 balcony and are a design outcome in response to the requirements stipulated in Condition C51 of Development Consent No. 86/22/2.

## **RELEVANT HISTORY**

## **Previous Applications**

Date	Action
30/11/2022	Development Application DA86/2022 for demolition of existing structures and construction of a residential flat building containing 21 apartments including basement parking and associated landscaping and civil works was approved by the Land and Environment Court on 30 November 2022.
04/10/2023	Modification Application No. 86/22/02 was granted consent by NSLPP on 4 October 2023. The scope of works under the modification application included alterations to basement levels including layout of parking and residential storage, modifications to the number and size of apartment layouts, amendments to landscaping, amendments to the design and size of the southern balconies and Level 5 western balcony and alterations to the roof plant and skylights.
	The Panel endorsed the Council Officer's report, recommendation and conditions subject to amendments to the Condition C51 which states: Balconies – Design Amendments
	C51 The southern balcony that serves Units 102 & 103 on Level 1, Units 202 & 203 on Level 2, Units 302 & 303 on Level 3, Unit 402 on Level 4 and Unit 502 on Level 5 is to be amended so not to be a continuous balcony but encompass a break in form as per that approved under DA 86/22 – LEC No. 2022/165233. The balconies subject to design amendments are

clouded in red on the approved plans in A7 of this modification application consent.
The Level 5 balcony on the western side of the building (Unit 501) is not approved and shall remain as per the balcony approved under determination for DA 86/22 – LEC No. 2022/165233. The respective balcony subject to design amendments is clouded in red on Level 5 Floor Plan, DA 2007 Rev F.
The floor plans (Levels 1-5) and elevations must be submitted to Council for the written approval of Council's Manager Development Services prior to the issue of any construction certificate.
(Reason: To ensure control in site density, maintenance in articulation in built form to the streetscape and minimise additional exceedance in site coverage)
On 1 November 2023, in response to the Panel determination the applicant submitted a 'To Satisfy DA Consent Condition Application' and lodged amended plans (Drawing No. 2002 – Ground Floor Plan, Rev G and Drawing No. 3101 – Section B, Rev G dated June 2023).
The applicant provided amended plans to address design changes required by the Panel as outlined by Condition Nos. C50 Ground Level Parking Design Change, C51 Balconies – Design Amendments & C52 Deep Soil Area. The plans were reviewed by Council Officers and satisfy the requirements of Conditions C50 and C52 only.
The requirements of Condition C51 Balconies – Design Amendments were not satisfied at this time. The amendments to the southern balconies and western balcony on Level 5 were beyond the scope of Condition C51 Balconies – Design Amendments and therefore amendments that do not strictly comply with the requirements of Condition C51 would require lodgement of a Section 4.56 Modification Application.

# **Current application**

Date	Action
12/02/2024	Modification Application No. 86/22/3 was lodged for a modification to address the requirements of Condition C51 and amend the form of the balconies to the
	southern elevation.
14/02/2024	Additional information was requested by Council following an initial review. An updated West Elevation was required noting alterations to the western Level 5 balcony and an updated Site Plan was required. A compliance diagram and notification plan were required.
	The Applicant submitted the additional information on 16 February 2024.
07/03/2024	A site visit was completed by the Assessment Officer.
08/03/2024	The application was notified to adjoining properties and the Neutral Precinct between 23 February and 08 March 2024.

18/03/2024	The applicant provided revised modified wording to Condition C51 requesting
	compliance with Condition C51 prior to a construction certificate for Stage 2 –
	Construction of basement slab including in-ground services if the Panel did not
	support the balcony design amendments.

#### CONSIDERATION

Council is required to assess the s4.56 application under the EPA Act 1979 (As amended) having regard to the following matters:

#### Section 4.56

- (a) it is satisfied that the development to which the consent as modified relates is substantially the same development as the development for which consent was originally granted and before that consent as originally granted was modified (if at all), and
- (b) it has notified the application in accordance with—
  - (i) the regulations, if the regulations so require, or
  - (ii) a development control plan, if the consent authority is a council that has made a development control plan that requires the notification or advertising of applications for modification of a development consent, and
- (c) it has notified, or made reasonable attempts to notify, each person who made a submission in respect of the relevant development application of the proposed modification by sending written notice to the last address known to the consent authority of the objector or other person, and
- (d) it has considered any submissions made concerning the proposed modification within any period prescribed by the regulations or provided by the development control plan, as the case may be.

Comments are provided on the above matters in section 4.56 as follows:

(a) it is satisfied that the development to which the consent as modified relates is substantially the same development as the development for which consent was originally granted and before that consent as originally granted was modified (if at all), and

The application involves alterations to the approved balconies on the southern elevation and alterations to the Level 5 western balcony and there are no new elements to be constructed as part of modifications. Consequently, the proposal is considered to be "substantially the same".

## (b) Whether the application has been notified and, if so, were there any submissions

The proposal did not require any referral to another public authority. The proposal was notified to adjoining properties and the Neutral Precinct between 23 February to 08 March 2024 and following notification no submissions were received.

Pursuant to section 4.56 (1A) in the EPA ACT 1979 (as amended) Council must also consider the matters that need to be addressed under section 4.15 (Evaluation) and the reasons for the grant of consent that is sought to be modified.

(1A) In determining an application for modification of a consent under this section, the consent authority must take into consideration such of the matters referred to in section 4.15(1) as are of relevance to the development the subject of the application. The consent authority must also take into consideration the reasons given by the consent authority for the grant of the consent that is sought to be modified.

**Comment:** with regards to the reasons for the grant of the original consent in accordance with Subsection 4.56(1A), the Court's judgment has been considered.

The judgment sets out the statutory considerations being jurisdictional requirements to the granting of consent. The proposed modifications to the balconies do not give rise to any new, or would be inconsistent with any former, prerequisite to the granting of consent.

With respect to Section 4.56 (1A) in the EPA Act 1979 and the requirement to consider reasons for the grant of consent it is an opportune time to consider the reasons for the grant of consent for Modification Application No. 86/22/2 and the requirements stipulated in Condition C51 Balconies – Design Amendments.

## **Consideration of the Proposed Balconies**

The panel reasons for the grant of consent of Modification Application No. 86/22/2 are stipulated as follows (*in italics*):

The Panel is of the view that excavation is to be minimised and deep soil optimised. The Panel also considers that the engineered deep soil areas are to be free of any continuous constructed slab.

The Panel is of the view that the street elevation would benefit from additional articulation to the balconies similar to the original approval.

The Panel agrees that the louvres can be replaced with concrete to allow floor to ceiling doors on the eastern elevation.

The proposed southern balcony that serves Units 102 & 103 on Level 1, Units 202 & 203 on Level 2, Units 302 & 303 on Level 3, Unit 402 on Level 4 and Unit 502 on Level 5 has a break in form providing additional articulation consistent with the second paragraph of the above Panel Reasons.

It is however noted that the amended balconies are not strictly designed as per that approved under DA 86/22 – LEC No. 2022/165233 therefore requiring determination by the Panel. The below figures provide a visual understanding between the plans approved by the LEC, those lodged subject to the previous modification and the current amended balconies. It is noted the current southern balconies especially the centrally sited balconies have an improved articulation and break in form compared to the previous modification.

Report of Thomas Holman, Senior Assessment Officer Re: 96-98 Ben Boyd Road, Neutral Bay



Figures 8, 9 & 10 – LEC Approved Level 1 Floor Plan, DA 2003 Rev C (left), Annotated Level 1 Floor Plan, DA 2003 Rev F approved by NSLPP (middle) and Amended Level 1 Floor Plan, DA 2003 Rev H (right)



Figures 11, 12 & 13 – LEC Approved Level 2 Floor Plan, DA 2004 Rev C (left), Annotated Level 2 Floor Plan, DA 2004 Rev F approved by NSLPP (middle) and Amended Level 2 Floor Plan, DA 2004 Rev H (right)



Figures 14, 15 & 16 – LEC Approved Level 3 Floor Plan, DA 2005 Rev C (left), Annotated Level 3 Floor Plan, DA 2005 Rev F approved by NSLPP (middle) and Amended Level 3 Floor Plan, DA 2005 Rev H (right)



Figures 17, 18 & 19 – LEC Approved Level 4 Floor Plan, DA 2006 Rev C (left), Annotated Level 4 Floor Plan, DA 2006 Rev F approved by NSLPP (middle) and Amended Level 4 Floor Plan, DA 2006 Rev H (right)



Figures 20, 21 & 22 – LEC Approved Level 5 Floor Plan, DA 2007 Rev C (left), Annotated Level 5 Floor Plan, DA 2007 Rev F approved by NSLPP (middle) and Amended Level 5 Floor Plan, DA 2007 Rev H (right)

In summary, the proposed plans with amendments to the southern balconies and the Level 5 western balcony although not being of a matching design compared to the balconies approved by the LEC are sufficient to satisfy the intent of Condition C51 Balconies – Design Amendments.

The modification application is also supported by a design report by MHNDUNION providing written and graphic supporting evidence for the proposed balconies (refer to Attachment 6).

# **MATTERS FOR CONSIDERATION UNDER SECTION 4.15 (Evaluation)**

## State Environmental Planning Policy (Housing) 2021

## Chapter 4 Design of Residential Apartment Development

In accordance with Section 115 of the *Environmental Planning and Assessment Regulations 2021*, the subject modification application made under section 4.56(1) of the Act is to be accompanied by a design verification statement.

A design verification statement prepared by Brian Meyerson Principal Reg. No. 4907 of MHN Design Union dated 19 March 2024 has been provided to satisfy Section 115 of the EP&A Regulations 2021. The statement demonstrates the modified development has satisfactorily addressed the Design Quality Principles in Schedule 1, the objectives in the ADG, and verified that the modifications do not diminish or detract from the design quality of the original development or compromise the design intent of the original development.

The proposed modifications are evaluated in accordance with the Design Quality Principles in Schedule 1 of the Policy.

## Principle 1: Context and neighbourhood character

The proposed modifications would improve the built form and character of the approved development. The proposed modifications to the external balcony design responds appropriately to the site context having regard to the interface with neighbouring apartments to the north and west.

## Principle 2: Built form and scale

The proposed modifications generally retain the built form and scale of the approved development. There is no increase to the maximum building height.

#### Principle 3: Density

The proposed modifications subject to Condition C51 Balconies would not alter the density of the approved development. The modifications result in no change to the quantity of apartments and no change to the building envelope.

#### Principle 4: Sustainability

The proposed modifications would not detract from the sustainability outcomes of the development. The minor modifications improve solar access and natural cross ventilation compliance with the ADG.

#### Principle 5: Landscape

No changes to the approved landscape design.

#### Principle 6: Amenity

The proposed modifications would improve the level of residential amenity of the approved apartments by facilitating improvements to the internal layout and configuration of the apartments and refining the privacy and solar shading devices, solar access and natural cross ventilation.

#### Principle 7: Safety

The proposed modifications would not detract from the safety and security of the approved development.

#### Principle 8: Housing diversity and social interaction

Consistent with approved development.

#### **Principle 9: Aesthetics**

The proposed modifications would not detract from the aesthetics of the approved development subject to the original Landscape Plan being implemented.

#### NORTH SYDNEY LOCAL ENVIRONMENT PLAN 2013

#### 1. Permissibility

The site is zoned R4 High Density Residential under the provisions of the North Sydney Local Environmental Plan 2013 (NSLEP 2013). Development for the purposes of a residential flat building is permissible with the consent of Council.

#### 2. **Objectives of the zone**

The objectives of the R4 High Density Residential Zone are stated below:

- To provide for the housing needs of the community within a high density residential environment.
- To provide a variety of housing types within a high density residential environment.
- To enable other land uses that provide facilities or services to meet the day to day needs of residents.
- To encourage the development of sites for high density housing if such development does not compromise the amenity of the surrounding area or the natural or cultural heritage of the area.
- To ensure that a reasonably high level of residential amenity is achieved and maintained.

The proposed modifications would not detract from the attainment of the objectives of the zone.

## 3. Height of Building

The subject site has a maximum permitted building height of 12m pursuant to clause 4.3(2) in NSLEP 2013.

The approved development included a variation to the development standard with a maximum building height of 13.65m exceeding the height control by 1.65m which is equivalent to a variation of 13.75%.

The proposed modified development is considered substantially the same development, and the modified balconies would not vary the development standard. The proposed modification involves no change to the maximum height of the building.

## NORTH SYDNEY DEVELOPMENT CONTROL PLAN 2013


The Development Control Plan applies to the site, so an assessment has been carried out below. Due to the specific scope of works proposed to the size and design of the southern balconies and Level 5 western balcony, a less expansive consideration is required of the criteria within Section 1 – Residential Development of the NSDCP 2013, however attention to detail is provided where relevant.

## **Environmental Criteria (Section 1.3)**

The proposed works being alterations to approved balconies maintains the amenity of surrounding properties having no additional bulk and scale which could affect neighbouring views, impact upon solar access or cause an unreasonable loss of visual privacy to the residents of adjoining properties. The southern balconies on each level are designed with solid walls to provide visual screening between each apartments respective balcony and there would be no change to the visual privacy of adjoining sites with no alterations sought to windows and doors of the building.

## **Quality Built Form (Section 1.4)**

The works would retain the existing siting, setbacks and form, massing and scale of the dwelling and generally retain the existing built form character. No alterations are proposed to the roof form or the elevations of the dwelling, and no alterations are proposed to the boundary fencing and stone wall on the Ben Boyd boundary. Conditions of consent will remain concerning works which may affect the public domain including tree protection measures, sediment and stormwater control and conditions concerning the proposed finishes, materials and colours of the building. The most applicable subsection in Section 1.4 that applies is s1.4.13 'Balconies – Apartments' of NSDCP 2013. Consideration of the applicable objective and provisions of s1.4.13 is detailed in the below condensed DCP table.

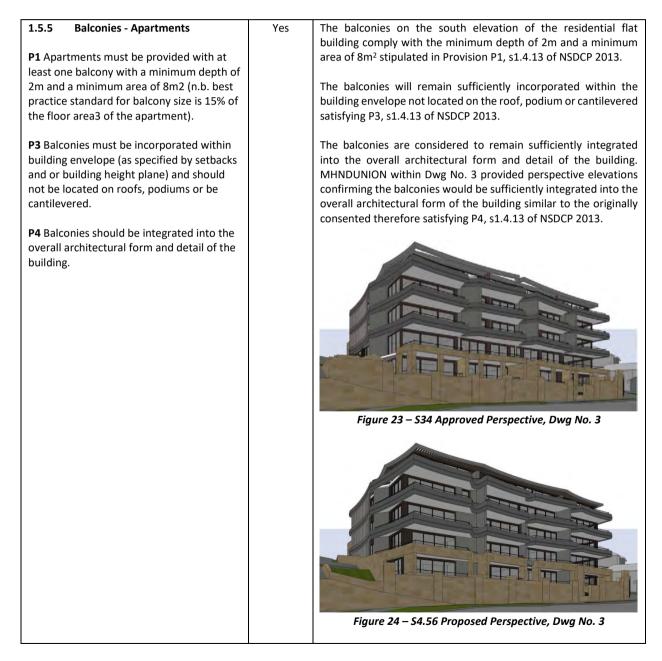


#### **Quality Urban Environment (Section 1.5)**

No alterations are proposed to vehicular access, car parking or landscaping. However, the balconies subject to alterations are defined as site coverage as per the definition in Provision P2, s1.5.5 of NSDCP 2013 therefore an assessment of site coverage is detailed in the below table.

1.5.5Site Coverage1.5.6Landscape Area (min) & Un-builtupon area (max)	Acceptable subject to Merit Assessment	The development was approved with a site coverage of $825m^2$ (48.55%). The modification application seeks an additional site coverage of $18m^2$ increasing the site coverage exceedance to 49.61% which is 4.61% greater than the minimum 45% tigulated in Table P. 1.6 of 1.5 of NSDCP 2012				
Site area = 225.9m <sup>2</sup> Table B-1.6: Site Coverage requirements         Residential Development       Cover (max)         Type       1         Residential Flat Building       45%		<ul> <li>stipulated in Table B-1.6, s1.5.5 of NSDCP 2013.</li> <li>The proposed site coverage is as per that proposed under the Modification Application No. 86/22/2.</li> <li>The panel determination amended Condition C51 Balconies permitting the side balconies to the south western and south eastern elevations on Level 1 – 5 which accrues additional site coverage.</li> <li>Below is an extract from Dwg No. 2 of the MHNDUNION design statement for the reasoning and justification for the amendment (<i>in italics</i>).</li> <li>The design changes we have made to the South-facing balconies as a result of feedback from the NSLPP maintain a commitment to the building's aesthetic and structural integrity, and with a continued commitment to the original principles set forth in the original DA.</li> <li>No objections are raised concerning site coverage because the balconies on the southern elevation propose additional articulation compared to that previously submitted for Modification No. 86/22/2. Furthermore, the southern balconies have a similarity in massing with the originally consented balconies on the south western &amp; south eastern corners of the building.</li> </ul>				



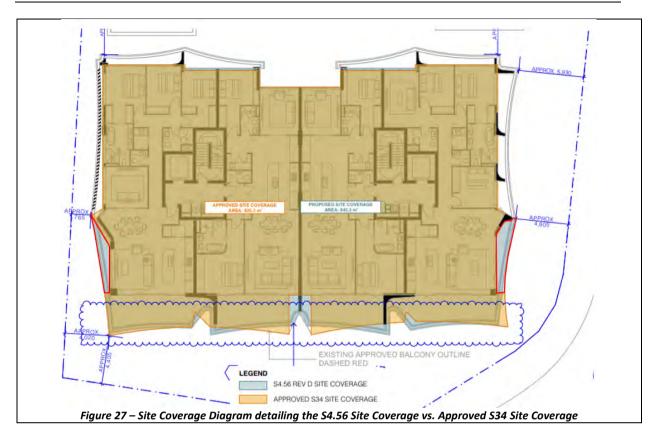

## CHARACTER STATEMENTS – PART C

The subject site is located within the Forsyth Neighbourhood of the **Neutral Bay Planning Area**.

The proposed modifications would not detract from the character of the area having regard to the desire future character and desired built form identified in Sections 7.0 and 7.1 of the character statement of Part C in NSDCP 2013.

## NORTH SYDNEY LOCAL INFRASTRUCTURE CONTRIBUTIONS PLAN

The North Sydney Local Infrastructure Contributions Plan 2020 has been developed in accordance with s7.11 and s7.12 of the *Environmental Planning and Assessment Act 1979*.

A further contribution is not applicable because the development has already been subject to a contribution levy. A monetary contribution was calculated for the original consent and a condition of consent (C42 – Section 7.11 Contributions) required the payment of **\$128,783.92** levy based on the cost of development. The proposed modifications would not notably increase the cost of works and therefore the existing condition remains appropriate.

Consequently, no further contribution is required.

ENVIF	RONMENTAL APPRAISAL	CONSIDERED
1.	Statutory Controls	Yes
2.	Policy Controls	Yes
3.	Design in relation to existing building and natural environment	Yes
4.	Landscaping/Open Space Provision	N/A
5.	Traffic generation and Carparking provision	N/A
6.	Loading and Servicing facilities	N/A
7.	Physical relationship to and impact upon adjoining development (Views, privacy, overshadowing, etc.)	Yes
8.	Site Management Issues	N/A
9.	All relevant S4.15 considerations of Environmental Planning and Assessment (Amendment) Act 1979	Yes
10.	Section 89 LGA 93 including Clause 12 Consideration of Local Government (Approvals) Regulation 1993	Yes

#### **PUBLIC INTEREST**

The proposal is considered to be in the public interest for the reasons stated throughout this report.

#### SUITABILITY OF THE SITE

The proposal would be located in a R4 High Density Residential Zone where residential flat buildings are a permissible form of development. Consequently, the proposal is considered to be suitable for the site having regard to the merits of the proposal as described in the above report.

#### SUBMITTERS CONCERNS

The subject application was notified to adjoining properties and the Neutral Precinct inviting comment between 23 February – 08 March 2024. There were no submissions raised following notification of the modification application.

#### **CONCLUSION & REASONS**

The proposal seeks to modify DA 86/22 to provide for an amended balcony design that encompasses a physical break in the built form as well as provide additional building articulation. The proposed amended design differs from the LEC Court approved design and that currently required by Condition C51.

The proposed southern balcony that serves Units 102 & 103 on Level 1, Units 202 & 203 on Level 2, Units 302 & 303 on Level 3, Unit 402 on Level 4 and Unit 502 on Level 5 has been amended to encompass a break in form providing additional articulation which is an improved outcome.

The proposed plans with amendments to the southern balconies and the Level 5 western balcony although not being of a matching design compared to the balconies approved by the LEC are considered sufficient to satisfy the intent of Condition C51 Balconies – Design Amendments.

The modifications do not result in any material amenity impact to adjoining properties or the surrounding area and no submissions have been received following notification of the modification application.

Having regard to the provisions of section 4.56 & 4.15(1) of the Environmental Planning and Assessment Act 1979, the proposed development as modified is substantially the same development as originally consented to. The application is therefore recommended for **approval**.

#### RECOMMENDATION

PURSUANT TO SECTION 4.55 OF THE ENVIRONMENTAL PLANNING AND ASSESSMENT ACT 1979 (AS AMENDED)

**THAT** the North Sydney Planning Panel exercising the functions of Council approve the modification of development consent DA 86/2022 dated 30 November 2022 in respect of a proposal to amendments to the southern and western balconies at 96-98 Ben Boyd Road, Neutral Bay under the provisions of Section 4.56 of the Environmental Planning and Assessment Act only insofar as will provide for the following:

#### A. Add Condition A8 as follows:

#### Development in accordance with Plans (s4.56 Amendments)

A8. The development being carried out in accordance with plans identified in Condition A1 of the consent endorsed with Council's approval stamp, except as modified by the modifications shown on:

Plan No.	Rev	Title	Drawn by	Received
DA 1002	Н	Site Plan	MHNDUNION	16/02/2024
DA 2002	Н	Ground Floor Plan	MHNDUNION	17/01/2024
DA 2003	Н	Level 1 Floor Plan	MHNDUNION	17/01/2024
DA 2004	Н	Level 2 Floor Plan	MHNDUNION	17/01/2024
DA 2005	Н	Level 3 Floor Plan	MHNDUNION	17/01/2024
DA 2006	Н	Level 4 Floor Plan	MHNDUNION	17/01/2024
DA 2007	Н	Level 5 Floor Plan	MHNDUNION	17/01/2024
DA 3001	Н	South Elevation	MHNDUNION	17/01/2024
DA 3003	Н	West Elevation	MHNDUNION	16/02/2024
DA 9103	Н	Site Coverage Diagram	MHNDUNION	16/02/2024


The Certifying Authority must ensure that the building plans and specifications, referenced on and accompanying the relevant Construction Certificate, fully satisfy the requirements of this condition.

(Reason: To ensure that the form of the development undertaken is in accordance with the determination of Council, Public Infrastructure)

## B. That Condition C51 of the consent be deleted

Thomas Holman	David Hoy
SENIOR ASSESSMENT OFFICER	TEAM LEADER

STEPHEN BEATTIE DEVELOPMENT SERVICES

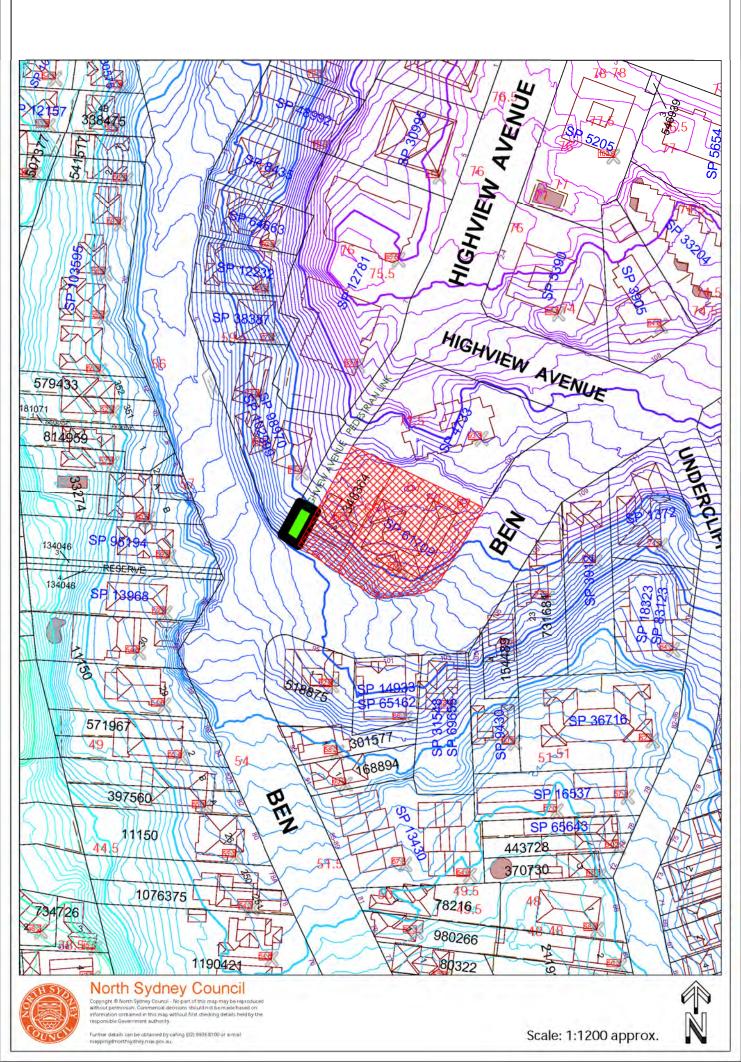

#### 96-98 BEN BOYD RD, NEUTRAL BAY NSW 2089

OCTOBER 28<sup>TH</sup>, 2022

DWG NO.	DRAWING NAME	REV
DA 0000	COVERPAGE	С
DA 0001	PROJECT SUMMARY	С
DA 1000	SITE CONTEXT	С
DA 1000	SITE PLAN	С
DA 1001	SITE ANALYSIS	С
DA 1003	DEMOLITION PLAN	С
DA 2000	BASEMENT 02 PLAN	С
DA 2001	BASEMENT 01 PLAN	С
DA 2002	GROUND FLOOR PLAN	С
DA 2003	LEVEL 1 FLOOR PLAN	С
DA 2004	LEVEL 2 FLOOR PLAN	С
DA 2005	LEVEL 3 FLOOR PLAN	С
DA 2006	LEVEL 4 FLOOR PLAN	С
DA 2007	LEVEL 5 FLOOR PLAN	С
DA 2008	ROOF PLAN	С
DA 3000	ELEVATION NORTH	С
DA 3001	ELEVATION SOUTH	С
DA 3002	ELEVATION EAST	С
DA 3003	ELEVATION WEST	С
DA 3100	SECTION A	С
DA 3101	SECTION B	С
DA 6000	EXTERNAL FINISHES 01	С
DA 6001	EXTERNAL FINISHES 02	С
DA 6002	PHOTOMONTAGE: BEN BOYD RD SOUTH	В
DA 6003	PHOTOMONTAGE: BEN BOYD RD NORTH	В
DA 6004	PHOTOMONTAGE: INTERNAL COURTYARD	В
DA 9100	SEPP 65 - SOLAR & CROSS VENTILATION	С
DA 9101	SEPP 65 - STORAGE	С
DA 9102	LANDSCAPE CALCULATION	С
DA 9103	SITE COVERAGE DIAGRAM	С
DA 9104	HEIGHT PLANE DIAGRAM	С
DA 9200	VIEWS FROM SUN - JUNE 21st	С
DA 9201	SHADOW DIAGRAMS - JUNE 21ST 9AM	С
DA 9202	SHADOW DIAGRAMS - JUNE 21ST 10AM	С
DA 9203	SHADOW DIAGRAMS - JUNE 21ST 11AM	С
DA 9204	SHADOW DIAGRAMS - JUNE 21ST 12PM	С
DA 9205	SHADOW DIAGRAMS - JUNE 21ST 1PM	С
DA 9206	SHADOW DIAGRAMS - JUNE 21ST 2PM	С
DA 9207	SHADOW DIAGRAMS - JUNE 21ST 3PM	C
DA 9208	SHADOW DIAGRAMS - EQUINOX 9AM	C
DA 9209	SHADOW DIAGRAMS - EQUINOX 12PM	C
DA 9210	SHADOW DIAGRAMS - EQUINOX 3PM	C
DA 9300	WASTE MANAGEMENT PLAN	C
DA 9300	ADAPTABLE UNIT - LEVEL 3 & 4	C
5,10001		0

	REV	DESCRIPTION	DATE	ALL CONSTRUCTION TO COMPLY AT MINIMUM W/ BCA CLAUSES & AUSTRALIAN STANDARDS		ARTIFICIAL LIGHTING: TO COMPLY WITH BCA PART CLAUSEF4.4 & AS1680 BALUSTRADE HEIGHTS: TO COMPLY WITH BCA CLAUSE D2.16	BASIX COMMITMENTS (ALL OTHER BASIX COMMITM PLANS)	INTS AS PER BASIX CERTIFICATE AND STAMPED			NOTES:	ARCHITECT:		DRAWING
	A	DEVELOPMENT APPLICATION	18/3/22	CLAUSE B 1.4 MATERIAL & FORMS CONSTRUCTIONS SPEC. C1.1 FIRE RESISTING CONSTRUCTION	CLAUSE D2.17 HANDRAILS CLAUSE D2.21 OPERATION OF LATCH	DRAINAGE GUTTERS & DOWNPIPES: TO COMPLY WITH ASINZS 3500.3.2 ENERGY EFFICIENCYGLAZING: TO COMPLY WITH J2 OF BCA FIRE SERVICES: TO COMPLY WITH SECTION E OF BCA	WATER OFTIONS SHOWERHEADS TOLETS	4 5598; (< 752 / min flow) 5 5598;	WATER HEATING ENERGY EFFICIENT LIGHTING COOK TOPS: VERTICAL TRANSPORT SYSTE ALTERNATIVE SYSTEM	Carrea gai to' waar system 2 LED Gai cookop, electric oven 38 Gearless traction 18 with VVF motor 1248 photovotaic system		MHNDU		COVER
	в	AMENDED DA SUBMISSION POST 34	28/10/22	SPEC. C1.10 FIRE HAZARD PROPERTIES SPEC. C.11 PERFORMANCE OF EXTERNAL WALLS IN A FIRE CLAUSE C2.6 VERTICAL SEPARATION OF OPENINGS IN EXTERNAL WALL	CLAUSE D2.23 SIGNS ON DOORS	HOT WATER: SYSTEMS TO COMPLY WITH PART J7 OF BCA MASONRY: TO COMPLY WITH AS3700 MECHIELECHYDRAULIC: BCA CLAUSE C3.15 & AS1530 4-2005	KITCHEN TAPS: BATHROOM TAPS: STORMMATER / RANIMATER TA COLLECT RUN OFF AREA: LANDSCAPED AREA TO RRIGAT	600 apm	THERMAL COMFORT OFTICHS R3.0 INSULATION TO: R2.5 INSULATION TO:	Exposed not & balconies (to achieve total minimum R-value of R0.2) External solid walls (to achieve total minimum R-			'I NIQI N	PROJECT
	с	AMENDED DA SUBMISSION POST 34	1/11/22	CLAUSE C2.12 SPEARATION OF EQUIPMENT CLAUSE C2.13 ELECTRICITY SUPPLY SYSYEM CLAUSE C3.2 PROTECTION OF OPENINGS CLAUSE C3.8 OPENING IN FIRE ISOLATED EXITS	CLAUSE D3.6 IDENT: OF ACCESSIBLE FACILISERVIFEATURES CLAUSE D3.8 TACTILE INDICATORS CLAUSE F1.7 WATERPROOFING OF WET AREAS	MECHANICAL AIRCONDITIONING: TO COMPLY WITH PART JS OF BCA MECHANICAL EXHANUST VENTILATION: TO COMPLY WITH AS1668 & AS68.2 SMOKE ALARMS: TO COMPLY WITH BCA PART CLAUSE & SPEC E2.2 &	ENERGY OFFICING COOLING & HEATING:	Single-phase air-conditioning, cooling 30-35 EER Rating, heating 35-40 EER Rating, Day-right zoned to Living and Bedoom areas	R20 INSULATION TO: R1.5 INSULATION TO:	value of R2.8) Underside of suspended concrete slabs between conditioned and internal non-conditioned space Internal walls between conditioned and non- conditioned zones its achieve total minimum R1.8		35 RICHARDS LANE SURRY HILLS SYDNEY NSW 20	010	96-98 BE
				CLAUSE C3.15 OPENING FOR SERVICE INSTALLATIONS CLAUSE D1.10 DISCHARGE FROM EXITS CLAUSE D2.7 INSTALLATIONS IN EXITS AND PATHS OF TRAVEL	CLAUSE F1.9/F1.10 DAMP PROOFING CLAUSE 2.5 CONSTRUCTION OF SANITARY COMPARTMENTS PART F4 LIGHTING AND VENTILATION CLAUSE F54 SOLIND INSULATION OF FLOORS	AS3786 PENETRATIONS: THROUGH FIRE RATED CONSTRUCTION FOR MECH/ ELECHYDRAULIC PENETRATIONS TO COMPLY WITH BCA CLAUSE C3.15 &	VENTLATION: - Apatment - Basement Car Park - Comma, Frie Pump Room	Individual fan, ducted to facade or roof, manual switch on' off, to Bathroom, Kitchen and Laundry annas Supply & enhaut controlled by CO <sup>2</sup> monitons + VSD fan Ventilation leahaut controlled		wills to internal non-conditioned zones) 01, Ue = 3.20 SHCC = 0.53 ep. Austrikum framed double-glacing Ue = 5.13 SHCC = 0.54		T +61 2 9101 1111 F +61 2 9101 1100	Nominated Architect	APPLICA
				CLAUSE D2.13 GOINGS AND RISERS CLAUSE D2.14 LANDINGS CLAUSE D2.15 THRESHOLDS	CLAUSE F5.5 SOUND INSULATION OF PEODIS CLAUSE F5.5 SOUND INSULATION OF SERVICES CLAUSE F5.7 SOUND INSULATION OF PEWIPS	AS1530 4-2005 SOUND TRANSMISSION: TO COMPLY WITH PARTS OF BCA STAIR CONSTRUCTION: TO COMPLY WITH BCA CLAUSE D2 13	- Garbage - Storage, Cold Water, Hot Water - Main Saitch Room - Lifts and Fire staircase - Lobbies	Vertilation (schaut on) ( Vertilation (schaut on)) with time clock or BMS controlled Vertilation (supply only) with time clock or BMS controlled No mechanical vertilation Vertilation (supply & enhaud) with time clock or BMS	101.104.501	eg, Auninium framed double-glacing Um = 7.3 SHGC = 0.79 Um = 5.13 SHGC = 0.54 eg, Auninium framed single glacing		MHN Design Union Pty Ltd. ABN 94 003 717 682	NSW Registration Number 4907	AIDOP NO SUITE 50
D	boumen	nt Set ID: 9158651		CLAUSE D2.16 BALUSTRADES		STAIR CONSTRUCTION: TO COMPLY WITH BCA CLAUSE D2.13 WATERPROOFING OF WET AREAS: TO COMPLY WITH AS3740		controlled						00112 00

Version: 1, Version Date: 16/12/2022



DA SUBMISSION POST 34	
ED	~
TE REMOVED. BUILDING ENVELOPE CONSOLIDATED	< <
LOCK. NS REDESIGNED, REDUCING BASEMENT FOOTPRINT	<
DN VOLUME. E CAR LIFT MOVED SOUTH.	
TS ON GROUND REPLACED WITH PARKING.	<
E TO NORTHERN SETBACK REINSTATED.	<
OPOSED RECONSTRUCTION OF EXISTING ROCK WALL	*
ERITAGE METHODOLOGY. APARTMENTS ON GROUND AND LEVEL 1 COMBINED	
REY UNITS.	<
RTMENT LAYOUTS REDESIGNED.	
OM ADDED TO GROUND FLOOR. STERN AND WESTERN SETBACK INCREASED.	
STERN AND WESTERN SETBACK INCREASED. SOUTHERN SETBACK ON LEVEL 5 INCREASED.	
REA, SITE COVERAGE, STORAGE AREA CALCULATIONS	-
S VENTILATION CALCULATIONS AMENDED. JN AND SHADOW DIAGRAMS UPDATED.	
EMENT PLAN UPDATED.	-
IT LAYOUTS UPDATED.	
DIAGRAM UPDATED.	
	-
	~~
	$\sim$
	2
DA SUBMISSION POST 34	
PEN SPACE CALCULATION AMENDED.	-
	4
·······································	لىن

# LAND & ENVIRONMENT COURT NSW APPROVED

Date: 30 November 2022

**ICATION** 1 and the second sec AP **OPMENT** DEVEL

AWING TITLE:	
VERPAGE	
DJECT ADDRESS:	LOT / SECTION / DP NO .:
98 BEN BOYD RD, JTRAL BAY NSW 2089	LOT A DP348364 & SP6170
PLICANT:	
OP NO 3 PTY LTD TE 506, LEVEL 5, 55 MILLE	R ST, PYRMONT NSW 2009

V / DP NO.: 364 & SP61709

1:1@A3 ISSUE DATE:

SCALE:

1/11/22 PROJECT NUMBER:

21-095

CHECKED:

REVISION: С

DWG NUMBER: DA 0000

DRAWN BY:

NOTES:

ENERGY OFTICHS COOLING & HEATING

Basement Car Park
 Comma, Fire Pump Room
 Carbage
 Storage, Cold Water, Hot II
 Hair Saidch Room
 Lifts and Fire statictase
 Lobbes

VENTLATION

A PART CLAUSE & SPEC E2.2 &

Single-phase air heating 3.5-4.01 Bedroom areas

Individual fai off, to Bathro Supply & ext Ventilation (r Ventilation (r)

- Sidegfixed ein + VSD fan C04, 101, 104, 5 y controlled - Sideg doors in 101, 104, 501

# **PROJECT SUMMARY**

	2 BED	3 BED	TOTAL	ACCESSIBLE
LEVEL 1	4	2	6	
LEVEL 2	0	4	4	
LEVEL 3	0	4	4	2
LEVEL 4	0	4	4	2
LEVEL 5	0	3	3	
	4	17	21	4
PARKING	RESIDENTIAL	VISITOR	TOTAL	ACCESSIBLE
CARS	29	4	33	5
MOTORBIKES	4	0	4	
BIKES	21	3	24	
STORAGE (m <sup>3</sup> ) 2HRS+ SOLAR	- EXTERNAL TOTAL	PROPOSED 456 m <sup>3</sup> 15 (71%)		CONTROL 8m <sup>3</sup> / 2 BED 10m <sup>3</sup> / 3 BED 202m <sup>3</sup> 14.7 (70%)
CROSS VENTIL		19 (90%)		12.6 (60%)
PRIVATE SPACE		644 m <sup>2</sup>		10m <sup>2</sup> / 2 BED
	_	044111	(19)	12m <sup>2</sup> / 3 BED
			$\sqrt{\frac{10}{1}}$	244m <sup>2</sup>
COMMUNAL O	PEN SPACE *	(426 m <sup>2</sup> (25.0	7%)	424.84 m <sup>2</sup> (25%)
DEEP SOIL *		REFER TO L	ANDSCAPE	118.95 m <sup>2</sup> (7%)
		ARCHITECT	S DOCUMENT	
SITE COVERAG	λE	825 m² (48.5	5%)	764.71 m² (45%)
	DG CONTROL			
* DENOTES A				SOIL PROVIDED TO SITE
* DENOTES A	LCULATIONS ARE			



Document Set ID: 9158651 Version: 1, Version Date: 16/12/2022

#### **REV B - AMENDED DA SUBMISSION POST 34**

 BASEMENT PLANS REDESIGNED, REDUCING BASEMENT FOOTPRINT AND EXCAVATION VOLUME. PARKING NUMBERS UPDATED.
 LANDSCAPED AREA, SITE COVERAGE, STORAGE AREA CALCULATIONS AMENDED.
 SOLAR & CROSS VENTILATION CALCULATIONS AMENDED.

·······

#### **REV C - AMENDED DA SUBMISSION POST 34**

19. COMMUNAL OPEN SPACE CALCULATION AMENDED.

# LAND & ENVIRONMENT COURT NSW APPROVED

Date: 30 November 2022

DRAWING TITLE:
PROJECT SUMMARY
PROJECT ADDRESS:
DOT / SECTION / DP NO.:
96:98 BEN BOYD RD,
NEUTRAL BAY NSW 2089
APPLICANT:
AIDOP NO 3 PTY LTD
SUITE 506, LEVEL 5, 55 MILLER ST, PYRMONT NSW 2009

SCALE: 1:1@A3 ISSUE DATE: 1/11/22

DRAWN BY:


CHECKED:

REVISION:


DWG NUMBER:

PROJECT NUMBER: 21-095

REF: BIMcloud: bcb.mhndu.com - BIMcloud Basic for An (221014)

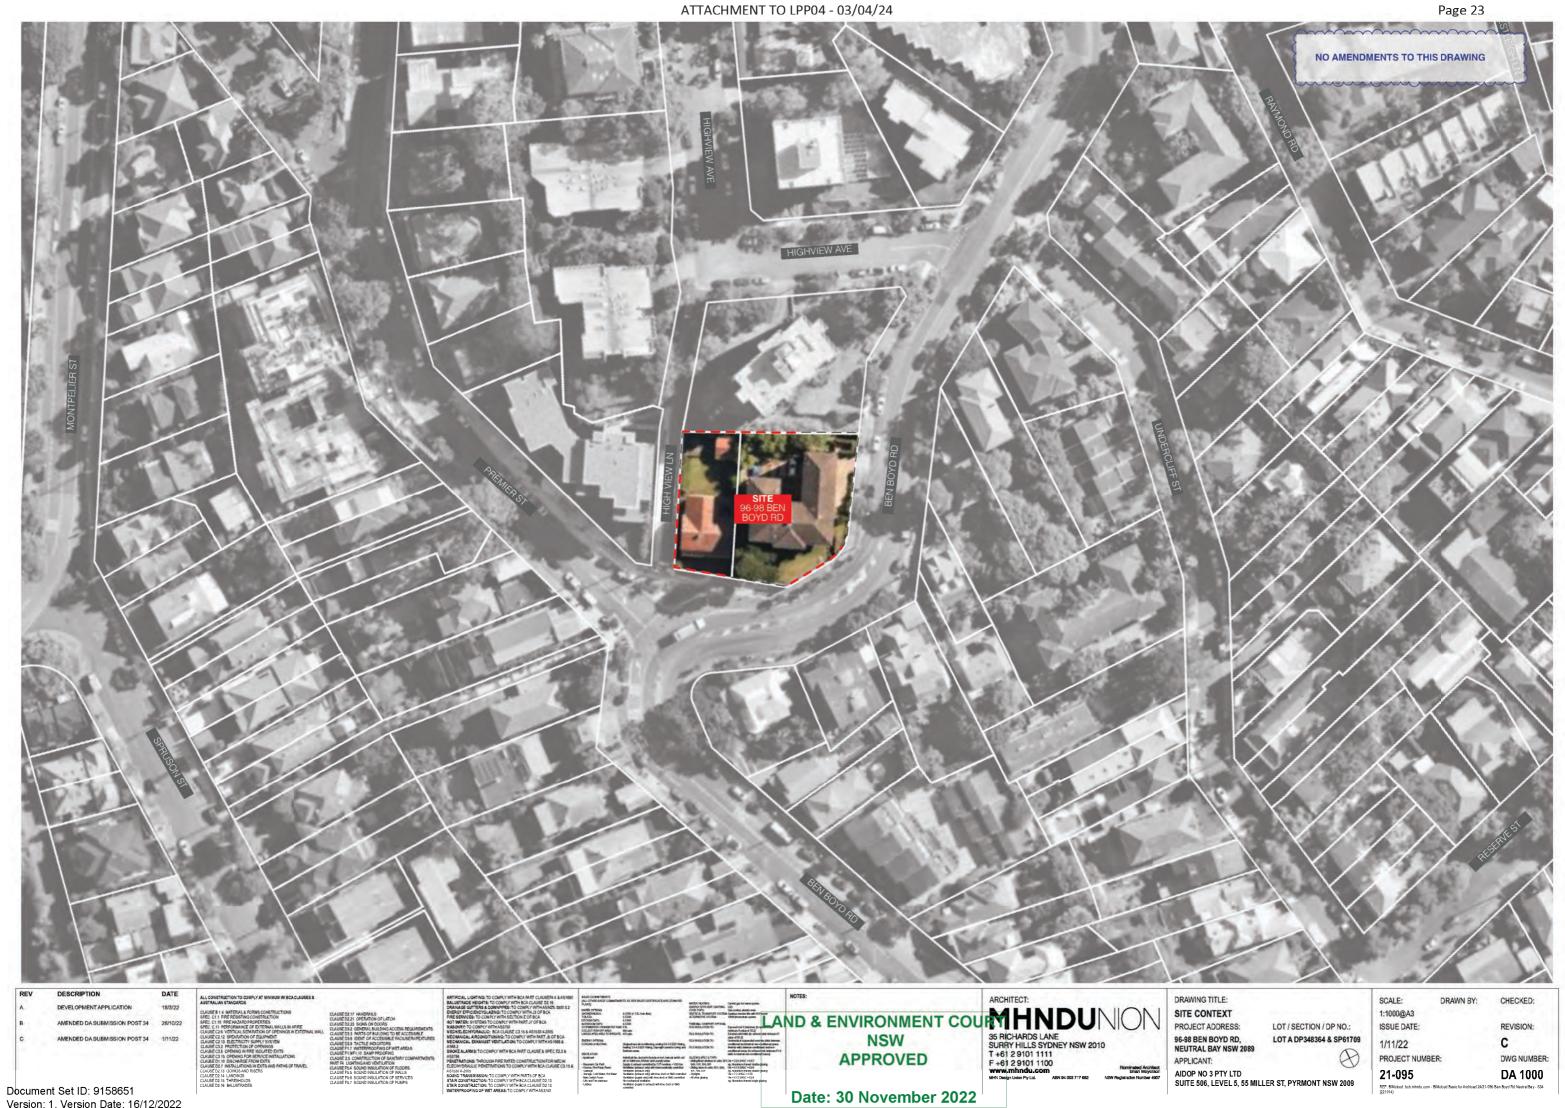

Version: 1, Version Date: 16/12/2022

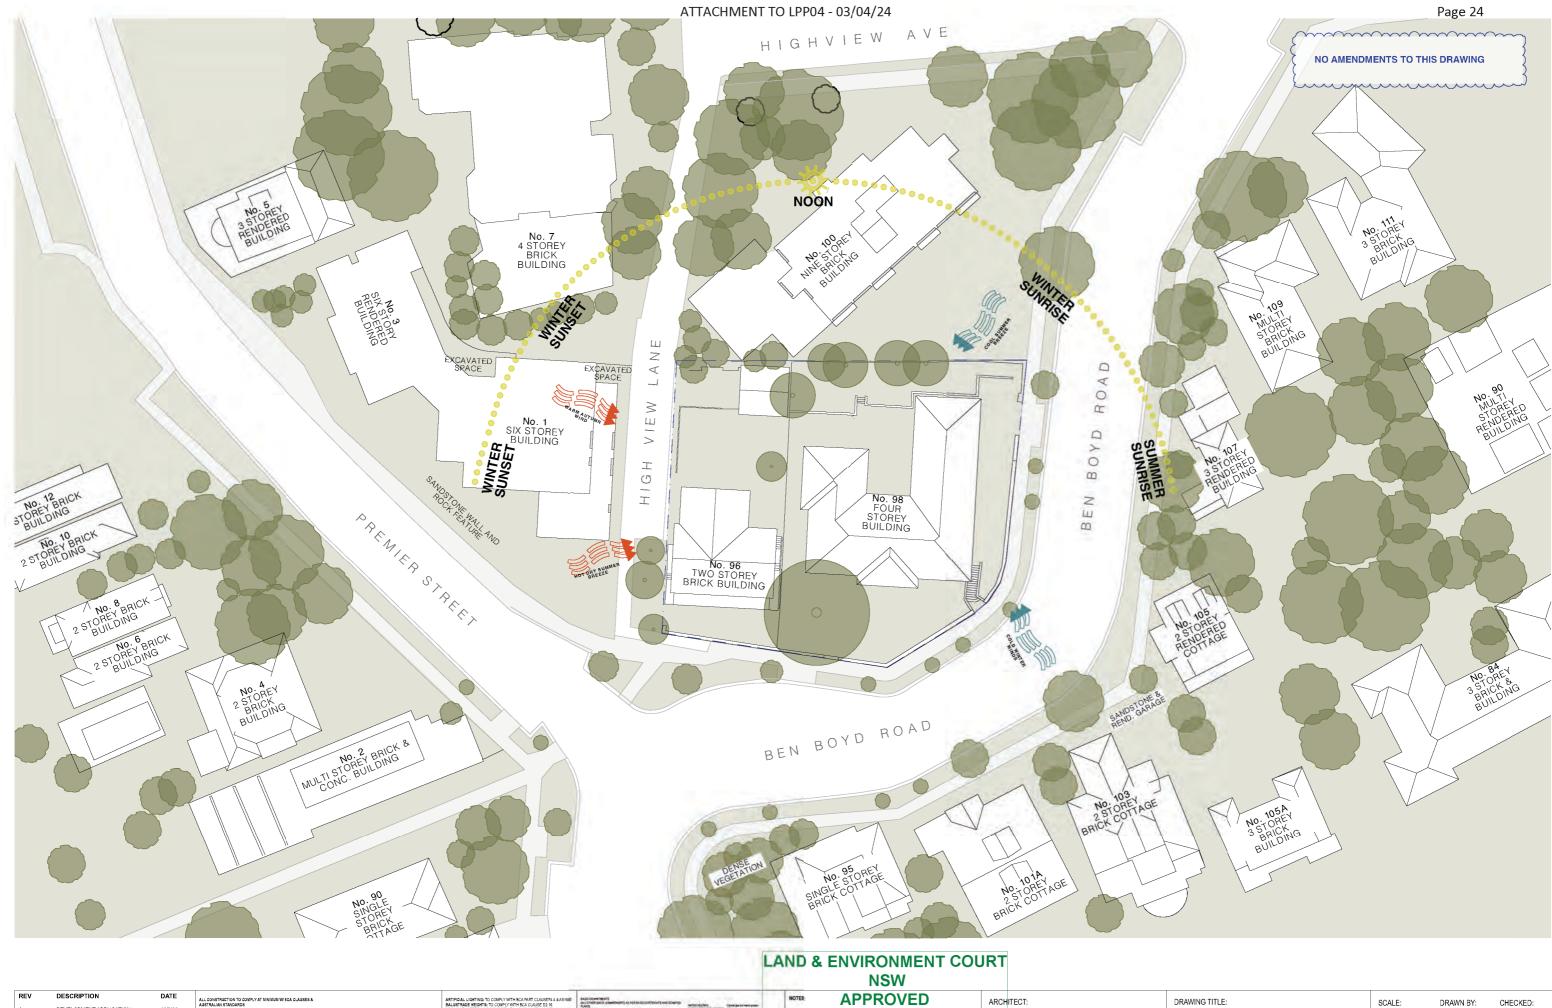

ARCHITECT: MHNDUNON 35 RICHARDS LANE SURRY HILLS SYDNEY NSW 2010 T +61 2 9101 1110 WWW.mhndu.com MeY Degrition FyLax ARM 94000 777 682 NWW Regression North of the State of North Regression North Regress DESCRIPTION DATE ALL CONSTRUCTION TO COMPLY AT MINIMUM W/ BCA CLAUSES & AUSTRALIAN STANDARDS **APPROVED** REV NOTES: Sector Advances of the sector DEVELOPMENT APPLICATION 18/3/22 Gas looks, Automatic over Gealest tection 26 with AMENDED DA SUBMISSION POST 34 28/10/2 Equipation International Additional of Conditional of Conditional Conditional of Conditional of Conditional Conditional of Conditional of Conditional of Conditional of Conditional Conditional of Date: 30 November 2022 AMENDED DA SUBMISSION POST 34 1/11/22 BIDST OFTONS COLUMN LINKING 01 101 101 September 10-tenting 10-4410 LARNS: TO COMPLY WITH BCA PART CLAUSE & SPEC E2.2 & HertLater Indexia Ing Buckson back an suit annual ainth an di a bahrann Anthar an Chaudy uma Sugh 2 anthan an Anthar an Chaudy uma Nardhan Johan an Still an Thannantado a saidh at Ianthana Johan an Still an Thannantado an Still Nardhana Johan an Still an Anthar an Chaunnaid Nardhana Johan an Still Anthar an Still Still Nardhana an Africa BLCINGPECT Sittyfhol arche GR, 101, 104, 501 Sitty Bursh on 101, 102, 501 -Shifte States party FIRE RATED CONSTRUCTION FOR MECH/ TIONS TO COMPLY WITH BCA CLAUSE C3.1 496 04154 -1215402 +151 a) Review from 0404 (bb) 1 bb; Un +6125402 +1514 a) Review Frank (bb)-(bb)-(b +125402+125 Un +6125402 +1514 a) Review Frank (b +6125402 +1514 a) Review Frank (b +6125402 +1514 b) Review Frank (b +6125402 +1514 b) Review Frank (b +6125402 +1514 b) Review Frank (b + 6125402 +1514 c) Review Frank (b + 6125402 +151402 +1 Searces Caribat Course, Nonling New Galage - Scrap, Castiller, No Marchaet New U.A. and New Selface - Later SOUND TRANSMI STAIR CONSTRUC STAIR CONSTRUC Document Set ID: 9158651 Version: 1, Version Date: 16/12/2022

DRAWING TITLE:

SITE ANALYSIS PROJECT ADDRESS: 96-98 BEN BOYD RD, NEUTRAL BAY NSW 2089 APPLICANT:

LOT / SECTION / DP NO .: LOT A DP348364 & SP61709  $\bigotimes$ 


1:500@A3 ISSUE DATE: 1/11/22 PROJECT NUMBER: CHECKED:

REVISION: С DWG NUMBER: DA 1001

AIDOP NO 3 PTY LTD SUITE 506, LEVEL 5, 55 MILLER ST, PYRMONT NSW 2009

REF: BIMck

21-095

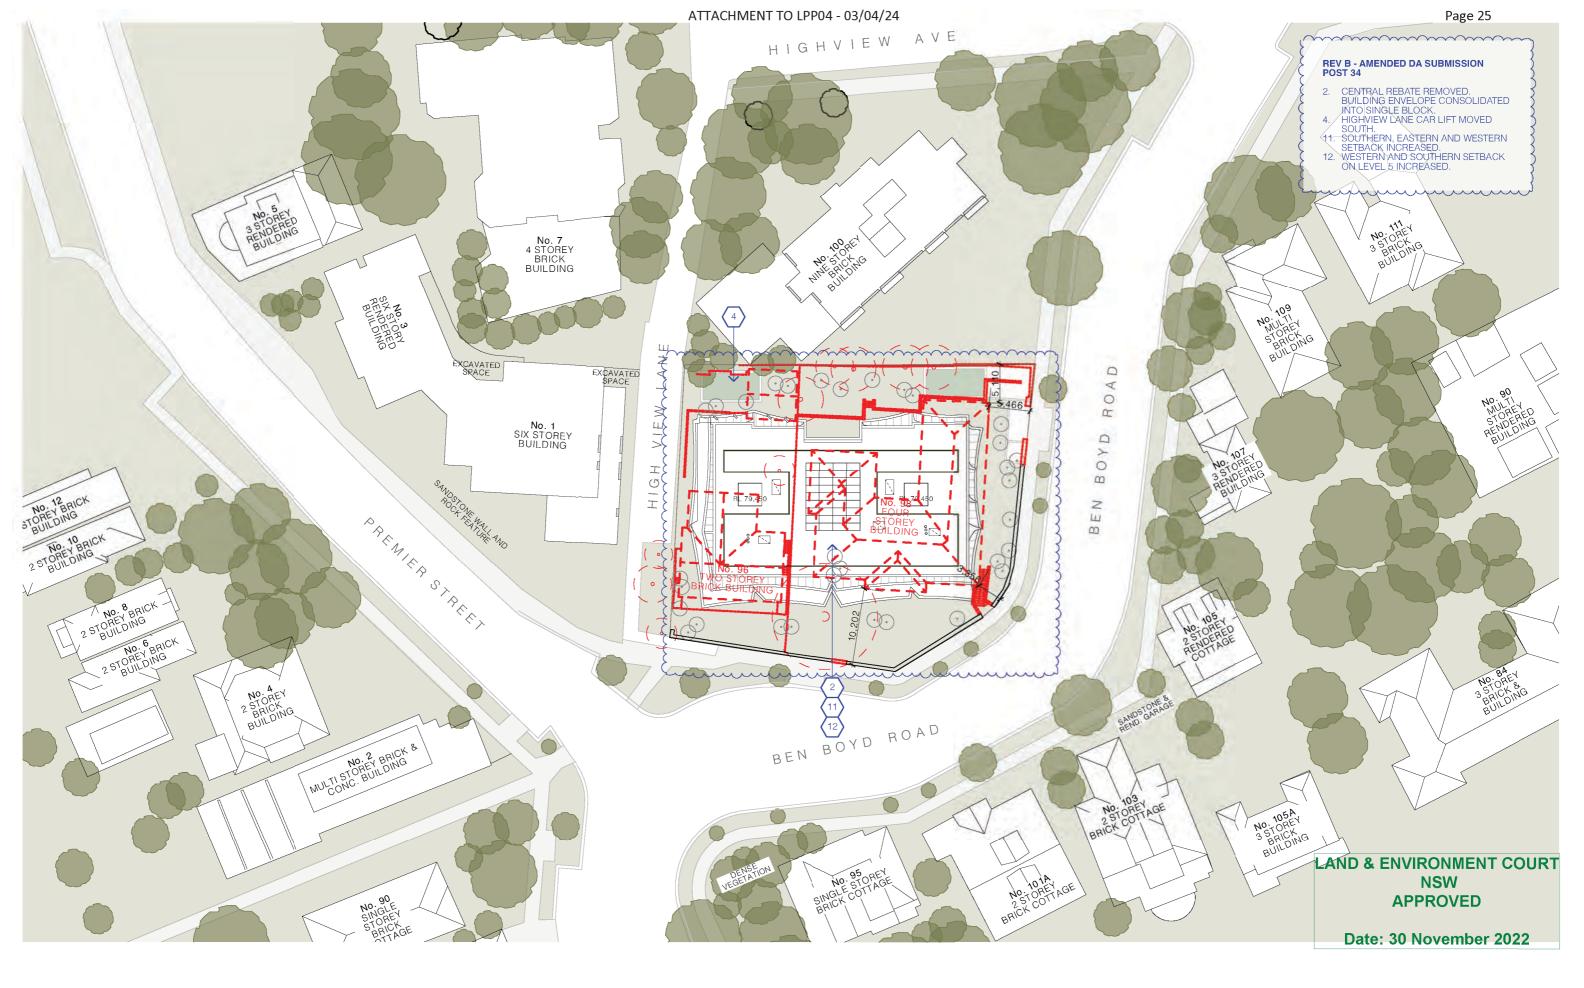

REV	DESCRIPTION	DATE	ALL CONSTRUCTION TO COMPLY AT MINIMUM W/ BCA CLAUSES & AUSTRALIAN STANDARDS		ARTIFICIAL LIGHTING: TO COMPLY WITH BCA PART CLAUSEF4 4 & AS1680 BALUSTRADE HEIGHTS: TO COMPLY WITH BCA CLAUSE D2 16	BASIX COMMITMENTS VALUOTHER BASIX COMMITME	INTS AS FER BASIX CERTIFICATE AND STANFED			NOTES:			ARCHITECT:			DRAWI
A	DEVELOPMENT APPLICATION	18/3/22	CLAUSE B 1.4 MATERIAL & FORMS CONSTRUCTIONS		BALOSI RADE HEIGHTS: TO COMPLY WITH BUA COUSE 02/16 DRAINAGE GUTTERS & DOWNPIPES: TO COMPLY WITH ASINZS 3500.3.2 ENERGY EFFICIENCYGLAZING: TO COMPLY WITH J2 OF BCA	PLANCE WATER OPTIONS		WRITER INFORMATING DIERSY DEPICTION LIGHT IN COOK TOPS:	Gas codes, distriction	EX	EXISTING	EX TREE TO REMOVE				
			SPEC. C1.1 FIRE RESISTING CONSTRUCTION	CLAUSE D2.17 HANDRAILS CLAUSE D2.21 OPERATION OF LATCH	FIRE SERVICES: TO COMPLY WITH SECTION E OF BCA FIRE SERVICES: TO COMPLY WITH SECTION E OF BCA HOT WATER: SYSTEMS TO COMPLY WITH PART JT OF BCA	SHOWERHEADS: TOLETS: KITCHENTAPS:	4 STAR (r 7.5L/min.fbw) 6 STAR 6 STAR	ALTERNATINE SYSTEM:	SBM Gealess tradien MS with WF notor S2MI photosoficie system	FFL	RL OF FINISHED	N22	MHN			SITE F
в	AMENDED DA SUBMISSION POST 34	28/10/22	SPEC. C1:10 FIRE HAZARD PROPERTIES SPEC. C:11 PERFORMANCE OF EXTERNAL WALLS N A FIRE CLAUSE C:26 VERTICAL SEPARATION OF OPENINGS IN EXTERNAL WALL	CLAUSE D2.23 SIGNS ON DOORS CLAUSE D3.2 GENERAL BUILDING ACCESS REQUIREMENTS	MASONRY: TO COMPLY WITH PART JI OF BCA MASONRY: TO COMPLY WITH ASS700 MECHIELECHYDRAULC: BCA CLAUSE C3.15 & AS1530 4-2005	KITCHENTAPS: BATHROOMTAPS: STORMARTER / RAINWATER TWO COLLECT REMOFF AREA:	6.534R K-S1L ABL sm	THERMAL COMPOSE OPTIC ROUMSULATION TO:	NS Episadrov/Abalonies (tradiove tradi ninkers Station (1923)	RL	FLOOR LEVEL REDUCED LEVEL	EX TREE TO RETAIN				PROJE
с	AMENDED DA SUBMISSION POST 34	1/11/22	CLAUSE C2.9 VENTICALSERARATION OF DIFINITIOS IN EXTERNAL WALL CLAUSE C2.12 SPEARATION OF EQUIPMENT CLAUSE C2.13 ELECTRICITY SUPPLY SYSYEM	CLAUSE D3.3 PARTS OF BUILDING TO BE ACCESSIBLE CLAUSE D3.6 IDENT. OF ACCESSIBLE FACIL/SERVIFEATURES	IN ECHIELECH TURAULIC: BCA CLAUSE C3.15 & AS1530 4-2005 NECHANICAL AIRCONDITIONING: TO COMPLY WITH PART JS OF BCA NECHANICAL EXHANUST VENTILATION: TO COMPLY WITH AS 1968 &	COLLECT RUN OFFAREA: LINEDCAPED AREA TO RIRGAT ENEMYL OPTIONS	E 40 sep	R25 INSULATION TO: R21 INSULATION TO:	Eternistid wils jo shiwe thinkings?- wile of 2.0 Underside of screen deformants-cate between		BOUNDARY EX BUILDING TO BE	PROPOSED LANDSCAPE	35 RICHARDS LA			96-98 B
			CLAUSE C3.2 PROTECTION OF OPENINGS CLAUSE C3.2 OPENING IN FIRE ISOLATED EXITS	CLAUSE D3.8 TACTILE INDICATORS CLAUSE F1.7 WATERPROOFING OF WET AREAS	AS68.2 SMOKE ALARMS: TO COMPLY WITH BCA PART OF AUSE & SPEC F2.2.8	COOLING-LIHEATING:	Single phase air conditioning, cooling 3:0-3:5 EER Parting heating 3:5-4.0 EER Parting, Day-night zonad to Using an Partners water	OF INTELIZING IN	and/kned and/knenial non-and/kned space htemai wala batawan conditioned and/con- and/toned azres. To advise total national R14		DEMOLISHED		SURRY HILLS SY		10	NEUTR
			CLAUSE C3.15 OPENING FOR SERVICE INSTALLATIONS CLAUSE D1.10 DISCHARGE FROM EXITS	CLAUSE F1.9/F1.10 DAMP PROOFING CLAUSE 2.5 CONSTRUCTION OF SANITARY COMPARTMENTS PART F4. LIGHTINGAND VENTILATION	AS3786 PENETRATIONS: THROUGH FIRE RATED CONSTRUCTION FOR MECH/	VENTILATION: - Apathetik	hdviduai hin, ducted to functe or tool, nanuai switch ori off, to Sathroom, Hitchan and Laundryamas	- Siding/find windows in units	valis to internal nan- and/koned same () i G01/Jan = 320 SHGC = 053				T +61 2 9101 111 F +61 2 9101 110			APPLIC
			CLAUSE D2.7 INSTALLATIONS IN EXITS AND PATHS OF TRAVEL CLAUSE D2.13 GOINGS AND RISERS	CLAUSE F5.4 SOUND INSULATION OF FLOORS	ELECHYDRAULIC PENETRATIONS TO COMPLY WITH BCA CLAUSE C3.15& A\$1530 4-2005	Baumant Car Park     Connet, Rite Pump Rom     Connet, Rite Pump Rom	Supply & unhase controlled by CO <sup>2</sup> numbers + VSD fam Vertilation (schourt only) with them outstalingly controlled Vertilation behaves and	Gal, 101, 104, 501 - Silding doors in units G01, Gi - 111 - 111 - GM					www.mhndu.con		Nominated Architect Brian Meyerson	
			CLAUSE D2.14 LANDINGS CLAUSE D2.14 LANDINGS CLAUSE D2.15 THRESHOLDS	CLAUSE F5.5 SOUND INSULATION OF WALLS CLAUSE F5.6 SOUND INSULATION OF SERVICES	SOUND TRANSMISSION: TO COMPLY WITH PARTS OF BCA STAR CONSTRUCTION: TO COMPLY WITH BCA CLAUSE D2 13	<ul> <li>Storage, Cold Water, Hot Water</li> <li>Main Switch Room</li> <li>Lifes and Fire staircase</li> </ul>	Vertilizion perhanza oriej with time dock or SMS-controlle Vertilizion Supply only with time dock or SMS-controller (its constantical evolution)		eg. Runinkun haned doble-gloding Usi = 7.3 SHC = 0.5 Usi = 5.13 SHC = 0.54 isi, Runinkun haned andie docho				MHN Design Union Pty Ltd.	ABN 94 003 717 682	NSW Registration Number 4907	AIDOP
Docume	ent Set ID: 9158651		CLAUSE D2:16 BALUSTRADES	CLAUSE F5.7 SOUND INSULATION OF PUMPS	STAIR CONSTRUCTION: TO COMPLY WITH BCA CLAUSE D2 13 WATERPROOFING OF WET AREAS: TO COMPLY WITH AS3740	- Lobbies	Verdision is popy 6 school with time dock or SNS controlled		g Annon and Support							SUITE
Version	: 1, Version Date: 16/12/	2022														

 RAWING TITLE:

 TE PLAN

 ROJECT ADDRESS:
 LOT /

 +98 BEN BOYD RD,
 LOT /

 SUTRAL BAY NSW 2089
 PPLICANT:

 POR NO. 0 DDV/DD
 DDV/DD

LOT / SECTION / DP NO.: LOT A DP348364 & SP61709 1:500@A3 ISSUE DATE: 1/11/22

SCALE:

PROJECT NUMBER: 21-095

DRAWN BY:


CHECKED:

REVISION:

C DWG NUMBER: DA 1000


DOP NO 3 PTY LTD JITE 506, LEVEL 5, 55 MILLER ST, PYRMONT NSW 2009

REF: BIMcloud: bcb.mhndu.com - BIMcloud Basic for Arch (221014)

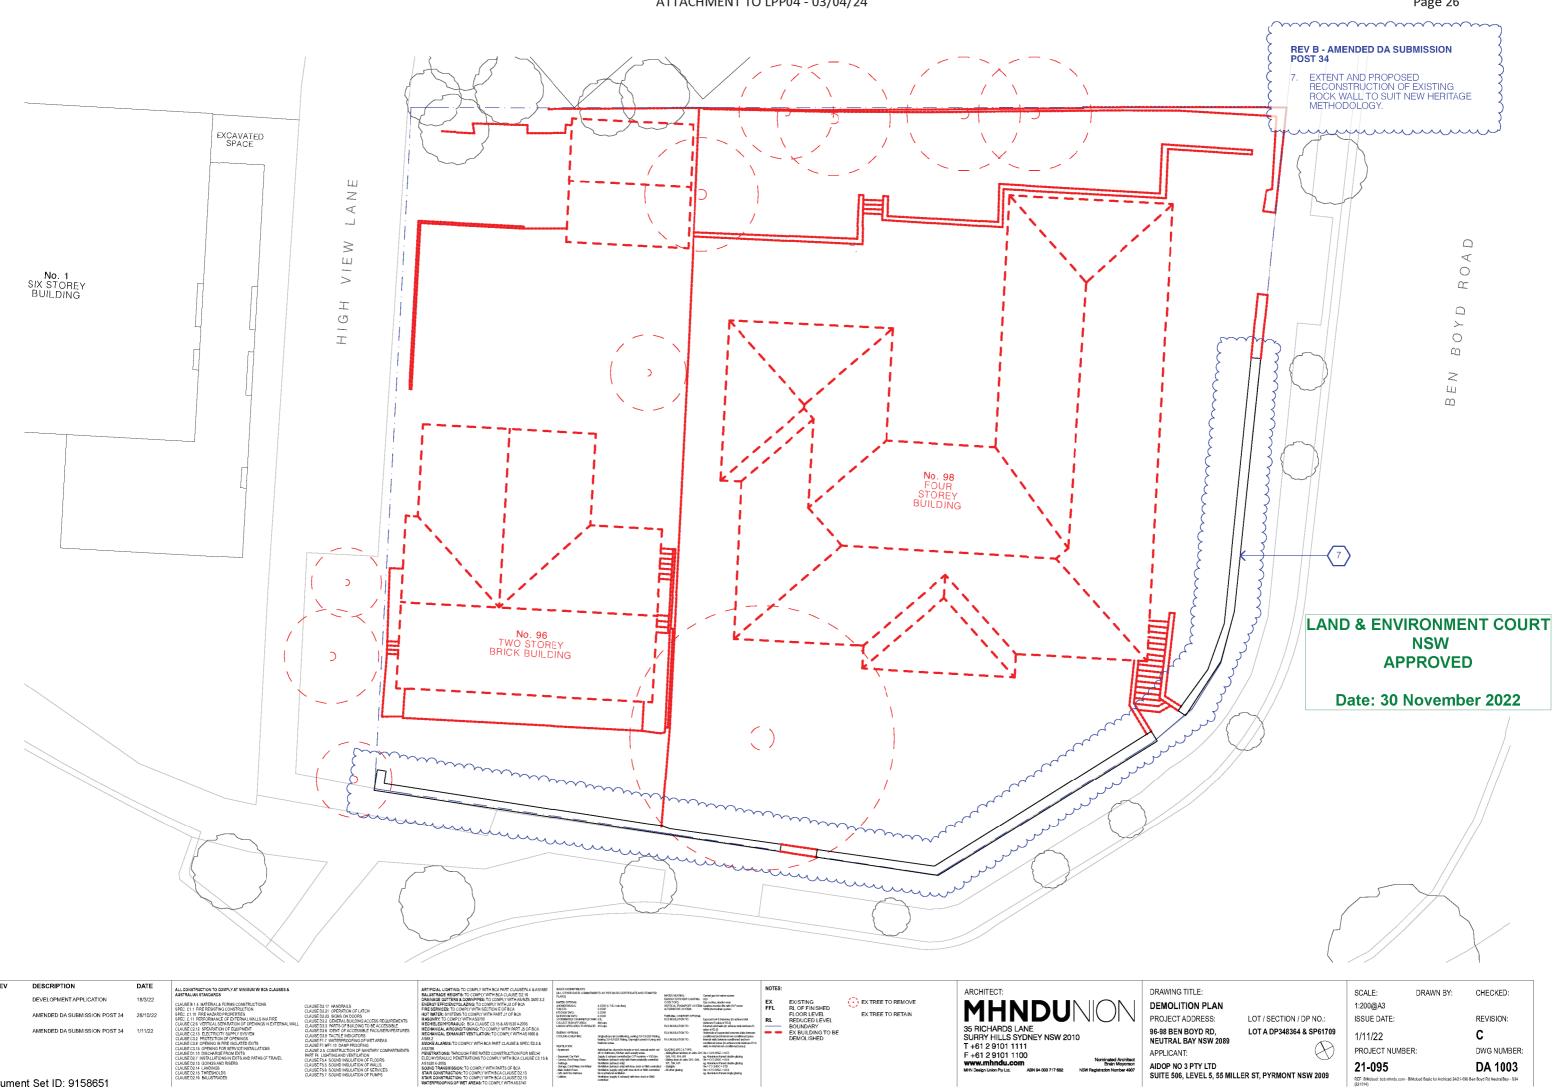

REV	DESCRIPTION	DATE	ALL CONSTRUCTION TO COMPLY AT MINIMUM W/ BC4 CLAUSES & AUSTRALIAN STANDARDS		ARTIFICIAL LIGHTING: TO COMPLY WITH BCA PART CLAUSEF4.4 & AS1680 BALLISTRADE HEIGHTS: TO COMPLY WITH BCA CLAUSE D2 16	BASIX CONVETWENTS OLL OTHER BASIX COUNT	MENTS AS PERIOASIX GERTIFICATE AND STANPED			NOTES:			ARCHITECT:			DRAWIN
A	DEVELOPMENT APPLICATION	18/3/22	CLAUSE B 1.4 MATERIAL & FORMS CONSTRUCTIONS		BALUSTRADE HEIGHTST TO COMPLY WITH BLA CLAUSE 02/16 DRAINAGE GUTTERS & DOWNPIPES: TO COMPLY WITH ASINZS 3500 3.2 ENERGY EFFICIENCYGLAZING: TO COMPLY WITH J2 OF BCA	PLANS		NATURINEATING: ENERGY EFFCIENT LIGHTN COOK TOPS:	Gas codes, dactio even	EX	EXISTING	EX TREE TO REMOVE				
в	AMENDED DA SUBMISSION POST 34	28/10/22	SPEC. C1.10 FIRE RESISTING CONSTRUCTION SPEC. C1.10 FIRE RESISTING CONSTRUCTION SPEC. C1.10 FIRE HAZARD PROPERTIES SPEC. C1.10 FERE FORMANCE OF EXTERNAL WALLS IN A FIRE C1 ALISE C24 VERTICAL SPEARATION OF DEPINIORS IN EXTERNAL WAL	CLAUSE D2.17 HANDRAILS CLAUSE D2.21 OPERATION OF LATCH CLAUSE D2.31 SIGNS ON DOORS CLAUSE D3.2 GENERAL BUILDING ACCESS REQUIREMENTS	EINERGE EFFICIENCE TSCALAINGE TO COMPLET WITH AS OF BOA FIRE SERVICESE TO COMPLY WITH ASCITION E OF BCA HOT WATER: SYSTEMS TO COMPLY WITH PART J7 OF BCA NASONRY: TO COMPLY WITH ASSITO NECHELECHYPRAULIC: BCA CLAUSE C3 15 & AS1530 4-2005	SHOWERHEADS: TOLETS: KITCHENTWYS: SKTINKCOMTWYS: STORMANTER/ISMANATER: COLLECT RUNOFF AREA: LANDSCAPED AREA TO PRIOR	4 5548 (c 755, lmin dow) 5 5548 6 5544 6 5544 6 554 1040 516, 6 00 5gm	ALTERNAL CONFORT OFFIC RELAYL CONFORT OFFIC RELAYLATION TO:	minimum Rivature of 1923	FFL RL	RL OF FINISHED FLOOR LEVEL REDUCED LEVEL	EX TREE TO RETAIN	MHN		NON	PROJEC
с	AMENDED DA SUBMISSION POST 34	1/11/22	CLAUSE C2.12 SPEARTION OF EXUIPINENT CLAUSE C2.12 SPEARTION OF EXUIPINENT CLAUSE C3.21 PROTECTION OF OPENINGS CLAUSE C3.30 PROTECTION OF OPENING CLAUSE C3.15 OPENING FOR SECURITE INSTALLATIONS CLAUSE C3.15 OPENING FOR UPUE TO ANY ATTACH CLAUSE C3.15 OPENING FOR UPUE TO ANY ATTACH CLAUSE C3.15 OCH AND AND THE TO ANY ATTACH ANY ATTACH AND ANY ATTACH AND ANY ATTACH ANY ATTACH AND ANY ATTACH AND ANY ATTACH ANY ATTACH AND ANY ATTACH ANY A	CLAUBE D33 PARTS OF AULDING TO BE ACCESSIBLE     CLAUBE D34 INDU FOR CACCESSIBLE ACCULAREVIEWER D45     CLAUBE D35 TACTILE INDUCTIONS     CLAUBE D35 TACTILE INDUCTIONS     CLAUBE D35 TACTILE INDUCTIONS     CLAUBE D35 TACTILE DAVE PRODORNIA     CLAUBE D35 TACTILE DAVE PRODORNIA     CLAUBE D35 TACTILIA DAVE PROLONO     CLAUBE D35 TACTILIA DAVE D35     CLAUBE D35	HECHWINGLALREQUICITIONIS: TO COMPLY INTH RRT 3: OF ECA BECANNICE, DEVAILABLY EVENTLATION TO COMPLY INTH RRT 3: OF ECA BECANNICE, DEVAILABLY EVENTLATION TO COMPLY INTH SR8 8: A 5820 SWICK ELAURES: TO COMPLY WITH BCA FRET CLAUSE & SPEC E2: 2: & A 58208 BECANNION USE DEPENDENCIES TO COMPLY WITH BCA CLAUSE CLI 5: & A 58308 4: 2505 SWIND TRANSMISSION: TO COMPLY WITH BCRT 5: CFCA	LARDSCAPED AREA TO RORS DEBYT OFTENS CODUMS STRATES - Rost CarPat - Saurant CarPat - Saurant CarPat - Saurant CarPat - Saurang, Caldillaur, Her Man - Sabrag	XE: 413 apr Single-frace since editoring, weiking 3-6-365587 Rolling, Sovieting Tuber (Second Second Sec	<ul> <li>GU2005SPEC&amp;TIPE: - Siding/field windows in units - Gui, 101, 104, 501</li> <li>- Siding dows in units G01, Gui 11, 104, 501</li> </ul>	Exercal add wilk to white with miniman fi- use and (2). If the second concrete data before and final add relation on additional data for and final add relation on additional data for additional targets to be additional with a similar additional targets to be additional with a second second second second second second targets and the second sec		BOUNDARY EX BUILDING TO BE DEMOLISHED		35 RICHARDS LA SURRY HILLS SYI T +61 2 9101 111 F +61 2 9101 110 www.mhndu.com	DNEY NSW 2010 1 10 1	0 Nominated Architect Brian Mayerson NSW Relatization Number 4907	96-98 BE NEUTRAI APPLICA
Docur	nent Set ID: 9158651		CLAUSE D2.15 THRESHOLDS CLAUSE D2.16 BALUSTRADES	CLAUSE F5.7 SOUND INSULATION OF PUMPS	STAIR CONSTRUCTION: TO COMPLY WITH BCA CLAUBE D2.13 STAIR CONSTRUCTION: TO COMPLY WITH BCA CLAUBE D2.13 WATERPROOFING OF WET AREAS: TO COMPLY WITH AS3740	- Main Sector Youth - Life and Fire shirtase - Lobbies	No netranis popy virgi ver mu doc or de central No netranis verblan Verbalan (opp) & ehaust) with time dock or 345 controllad	a -nonegang	ag, Aminian travel single-gitzing				kenn Design Union Pty Ltd.	ABR 94 003 7 17 082	NSW Registration Number 4907	SUITE 50
Versic	on: 1, Version Date: 16/12	/2022														

Page 26

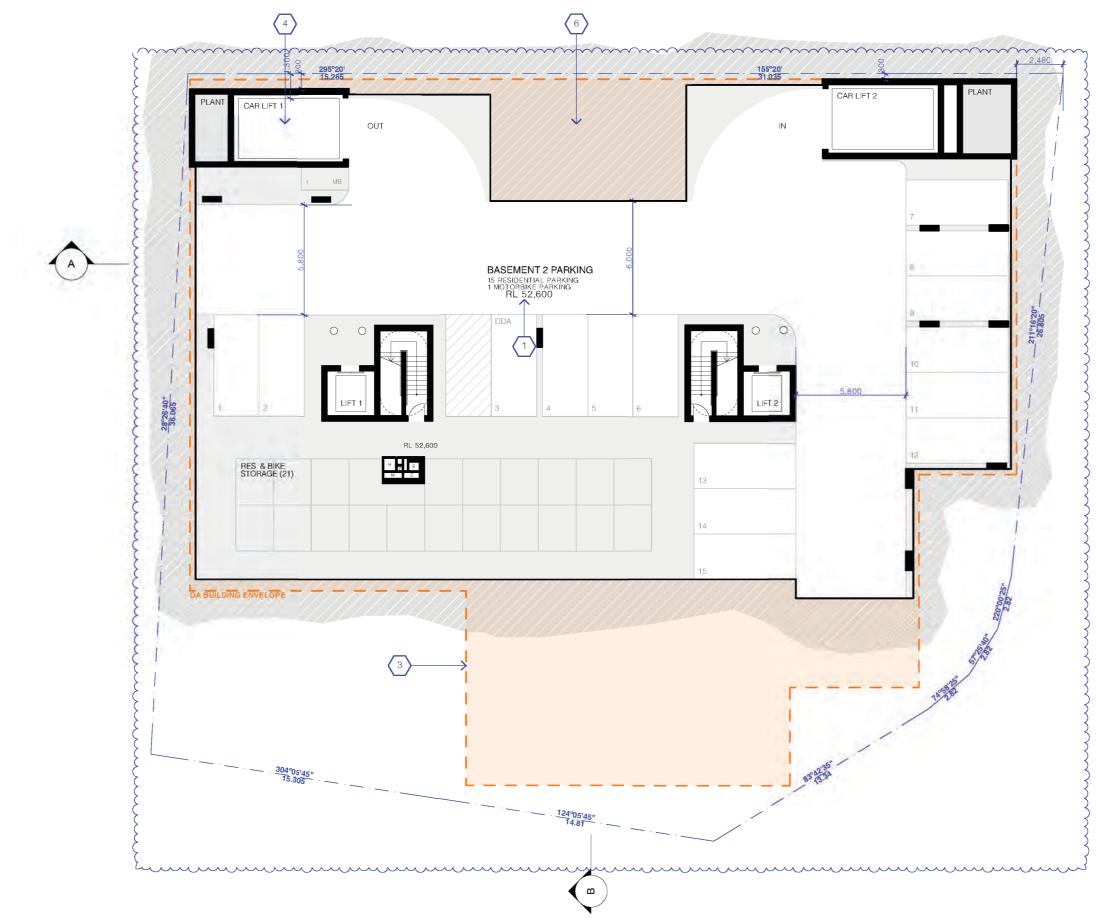



Version: 1, Version Date: 16/12/2022

Page 27

DRAWING TITLE: BASEMENT 02 PLAN PROJECT ADDRESS: 96-98 BEN BOYD RD, NEUTRAL BAY NSW 2089



 $\bigotimes$ 

SCALE:

1:200@A3 ISSUE DATE: 1/11/22 PROJECT NUMBER: 21-095


DRAWN BY:

CHECKED: REVISION:

C DWG NUMBER: DA 2000

AIDOP NO 3 PTY LTD SUITE 506, LEVEL 5, 55 MILLER ST, PYRMONT NSW 2009

REF: BIMolou

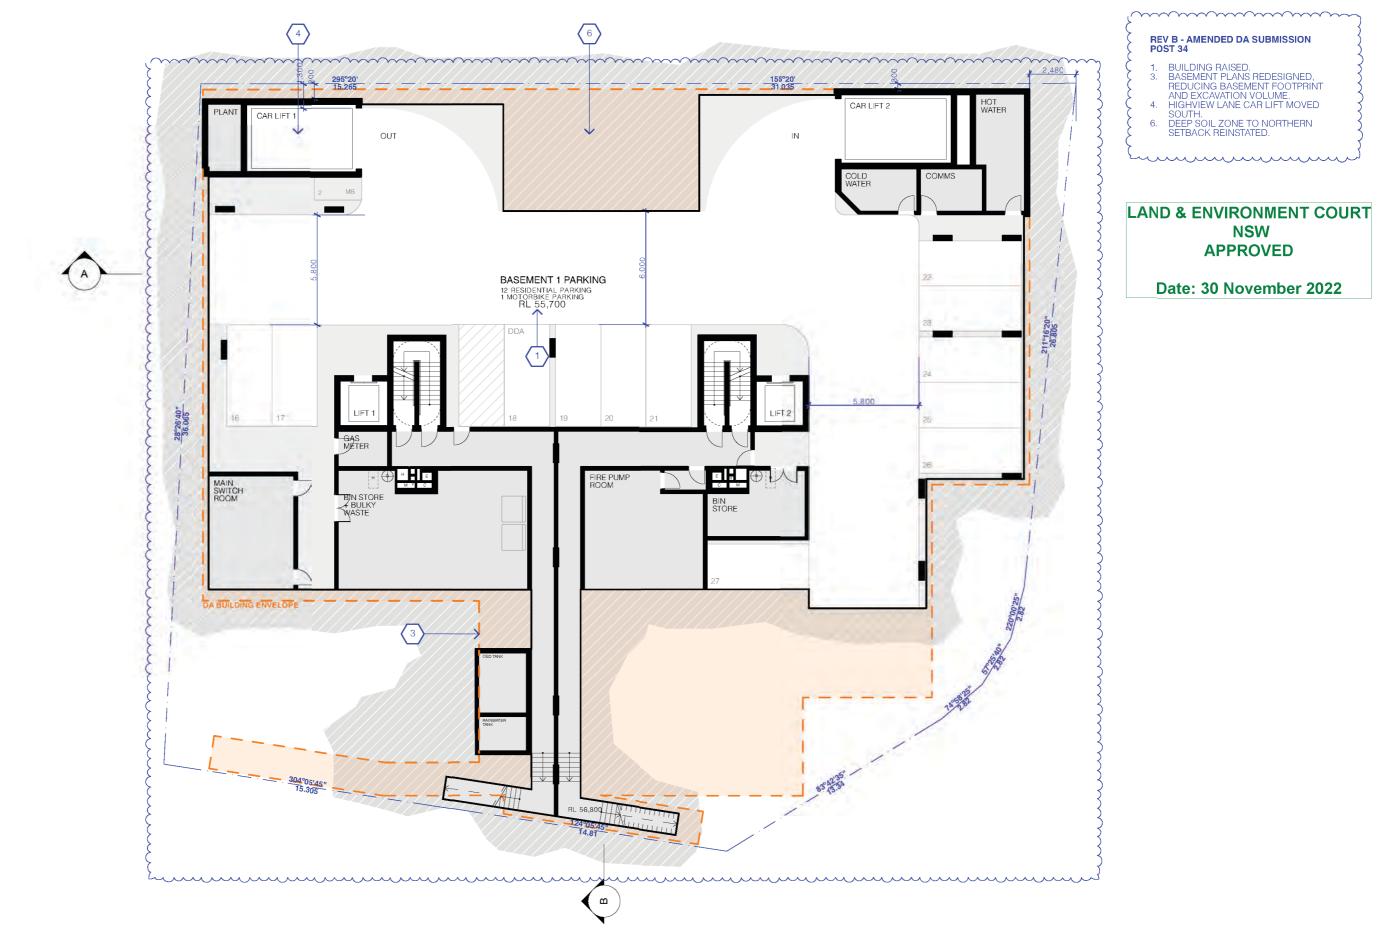



Version: 1, Version Date: 16/12/2022

Page 28

DRAWING TITLE: BASEMENT 01 PLAN

PROJECT ADDRESS: 96-98 BEN BOYD RD, NEUTRAL BAY NSW 2089 APPLICANT:




 $\bigotimes$ 

SCALE: DRAWN BY: CHECKED: 1:200@A3 ISSUE DATE: REVISION: 1/11/22 С PROJECT NUMBER: 21-095

DWG NUMBER: DA 2001

AIDOP NO 3 PTY LTD SUITE 506, LEVEL 5, 55 MILLER ST, PYRMONT NSW 2009


REF: BI

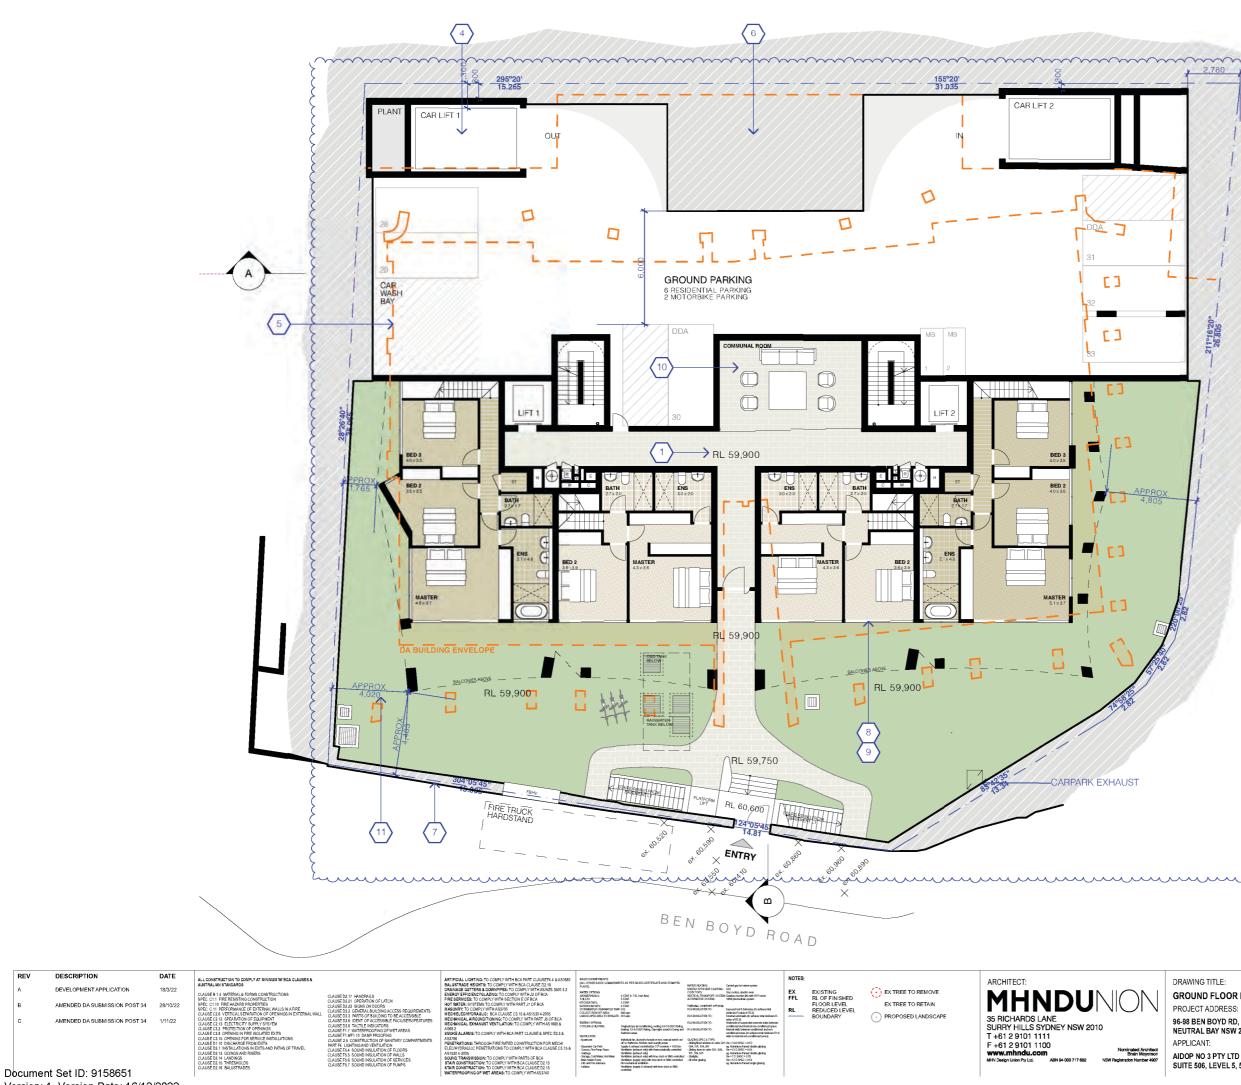

Version: 1, Version Date: 16/12/2022

REV

Page 29

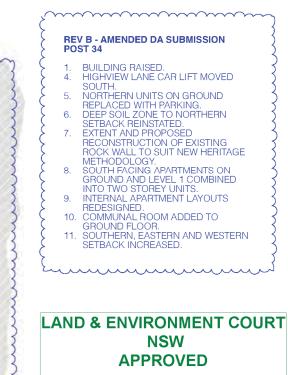

Date: 30 November 2022

DRAWING TITLE:

26.805

GROUND FLOOR PLAN PROJECT ADDRESS: 96-98 BEN BOYD RD, NEUTRAL BAY NSW 2089 APPLICANT:



1:200@A3 ISSUE DATE: 1/11/22 PROJECT NUMBER: 21-095

SCALE:


DRAWN BY:

CHECKED:

REVISION: С DWG NUMBER:

DA 2002

AIDOP NO 3 PTY LTD SUITE 506, LEVEL 5, 55 MILLER ST, PYRMONT NSW 2009

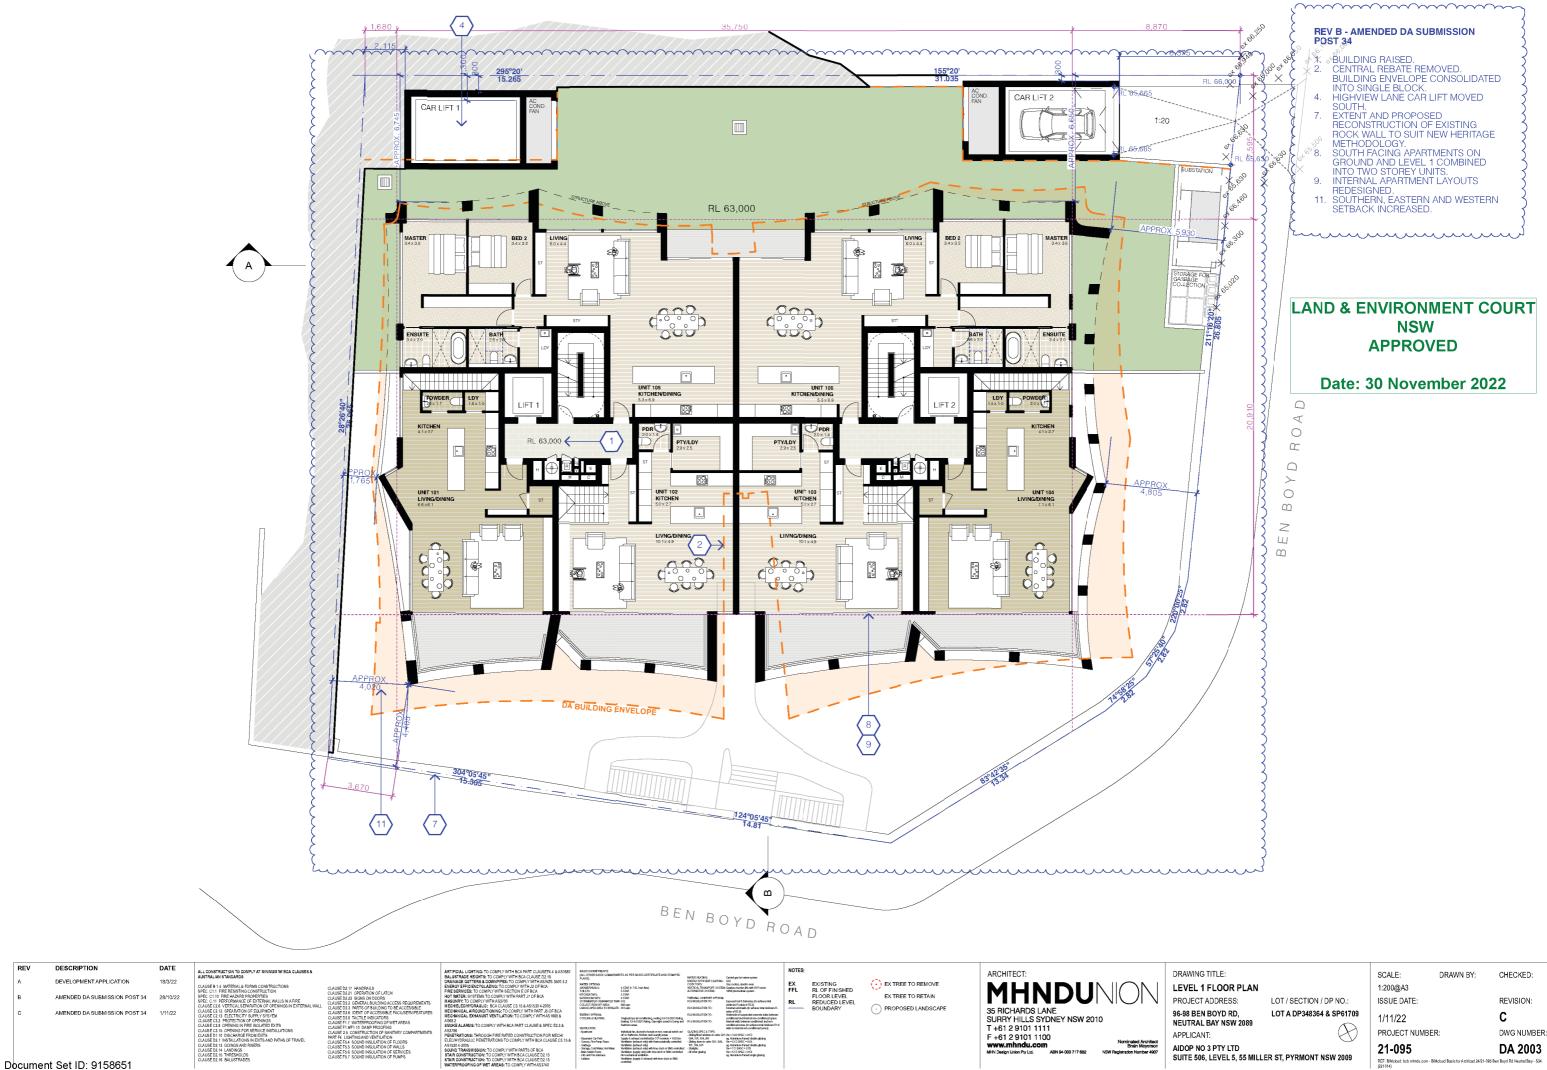

Version: 1, Version Date: 16/12/2022

DESCRIPTION

REV

Page 30



Version: 1, Version Date: 16/12/2022

DESCRIPTION

REV

Page 31



PROPOSED LANDSCAPE

660.50

Singleshase air conditioning, cooling 20-35 SSR Rail huating 35-4,0 SSR Rating, Deweight zonadro Gaing Sectors unus

Individual An, ducted to Academ off, to Suffroom, Northan and La Supply & anhanc controlled by Versition Johanst only with the Versition Johanst only with the Versition Johanst only with the Versition Lapply only with the Normachanical workford

INSULATION TO: INSULATION TO:

ris O(U) = 320 SHOC = 053 sg. Aztrikan frand dudle-glazing (sk. Un = 512 SHOC = 054 sg. Aztrikan frand dudle-glazing Un = 512 SHOC = 054 Un = 512 SHOC = 054

GLAZING SPECA TH - Skingfinal vindows GM, 101, 104, 501 - Sking dors in units 101, 104, 501 - Shingtos - Shingtos

nius nitus + VSOrlan staaly contralled

ne doct or SAS controlled a clock or SAS controlled

ENERSY OPTIONS COOLING 4 HEATING:

ALARNIS: TO COMPLY WITH BCA PART CLAUSE & SPEC E2.2 &

DMPLY WITH PARTS OF BCA DMPLY WITH BCA CLAUSE D2 13 WPLY WITH BCA CLAUSE D2 13

ED CONSTRUCTION FOR MECH/ COMPLY WITH BCA CLAUSE C3.15.8

19/11/41/01: -Apathent - Seament Car Part - Connex, Pice Party Room - Gottage - Sangag, Cold Naza, Harti - Main Sakth Room - Ukbasand Fire Sakrase - Lubbias

Document Set ID: 9158651 Version: 1, Version Date: 16/12/2022

DESCRIPTION

DEVELOPMENT APPLICATION

AMENDED DA SUBMISSION POST 34

1/11/22

SPEARATION OF EQUIPMENT ELECTRICITY SUPPLY SYSYEM

REV

Page 32

PROJECT ADDRESS: 96-98 BEN BOYD RD, NEUTRAL BAY NSW 2089 APPLICANT: AIDOP NO 3 PTY LTD


ominated An Brian Me



ISSUE DATE: 1/11/22 PROJECT NUMBER: 21-095

С DWG NUMBER: DA 2005

SUITE 506, LEVEL 5, 55 MILLER ST, PYRMONT NSW 2009

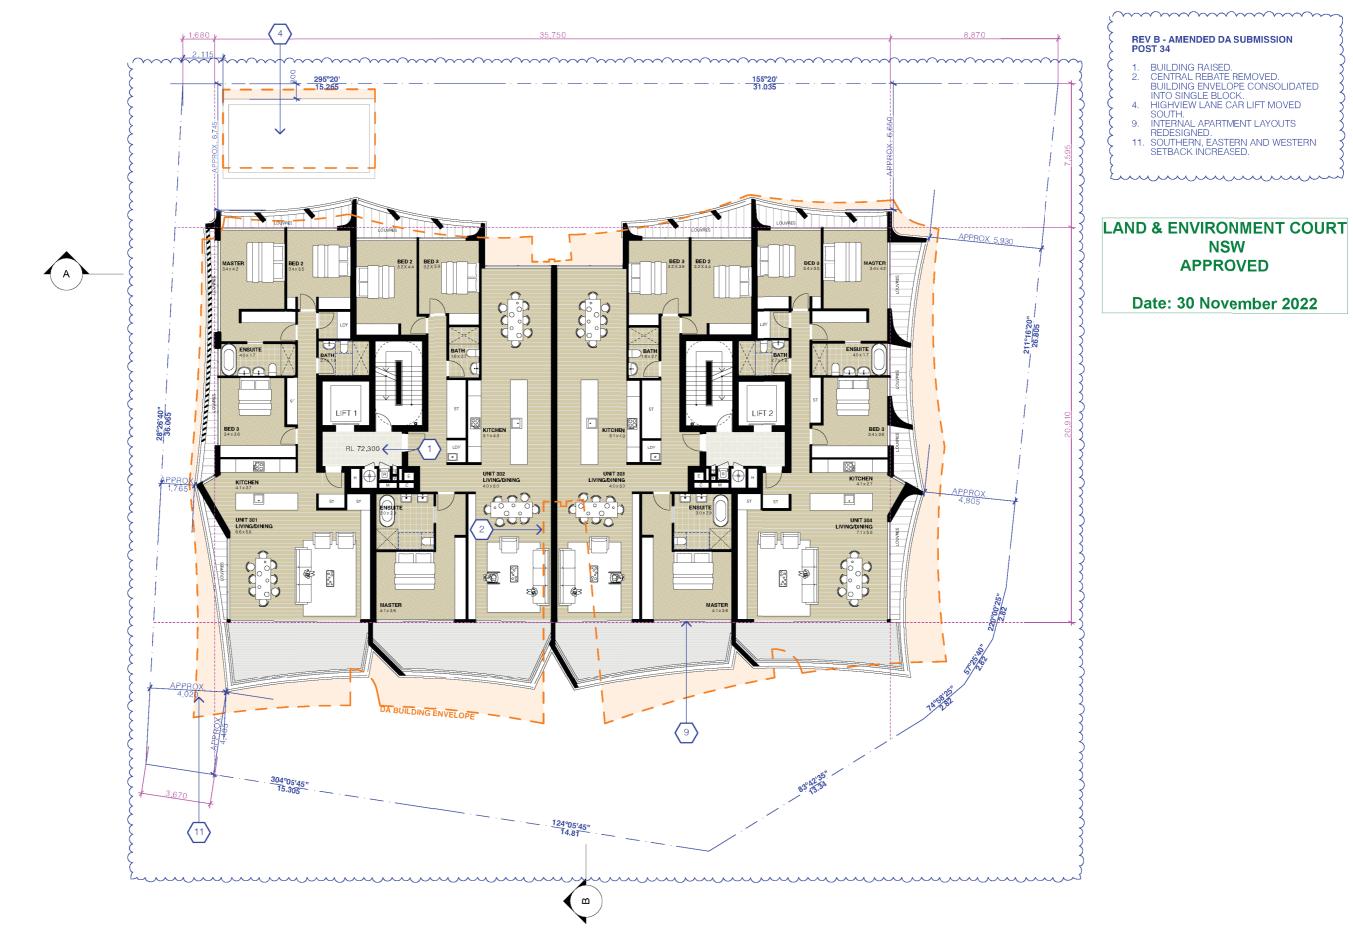



Version: 1, Version Date: 16/12/2022

Page 33

DRAWING TITLE: LEVEL 4 FLOOR PLAN PROJECT ADDRESS: LC 96-98 BEN BOYD RD, LC NEUTRAL BAY NSW 2089 APPLICANT: AIDOP NO 3 PTY LTD OUTRE FOR THE FLORE OF EMULIE FOR



ISSUE DATE: 1/11/22 PROJECT NUMBER: **21-095** 

SCALE:

1:200@A3

DRAWN BY:

CHECKED:

REVISION: C DWG NUMBER: DA 2006

SUITE 506, LEVEL 5, 55 MILLER ST, PYRMONT NSW 2009

REF: BIMckoud: bcb.mhrdu.com - BIMckoud Basic for Archicad 24/2 (221014)





Page 34

DRAWING TITLE: LEVEL 5 FLOOR PLAN PROJECT ADDRESS: LOT 96-98 BEN BOYD RD, LOT NEUTRAL BAY NSW 2089 APPLICANT: AIDOP NO 3 PTY LTD SUITE 606 LEVEL 6 66 MILLED ET



1/11/22 PROJECT NUMBER: **21-095** 

REF: BI

SCALE:

1:200@A3

ISSUE DATE:

DRAWN BY:


CHECKED:

REVISION: C DWG NUMBER:

10 bob.mindu.com - BIMoloud Basic for Archicad 24/2

DA 2007 21-095 Ben Boyd Rd Neutral Bay - \$34

SUITE 506, LEVEL 5, 55 MILLER ST, PYRMONT NSW 2009

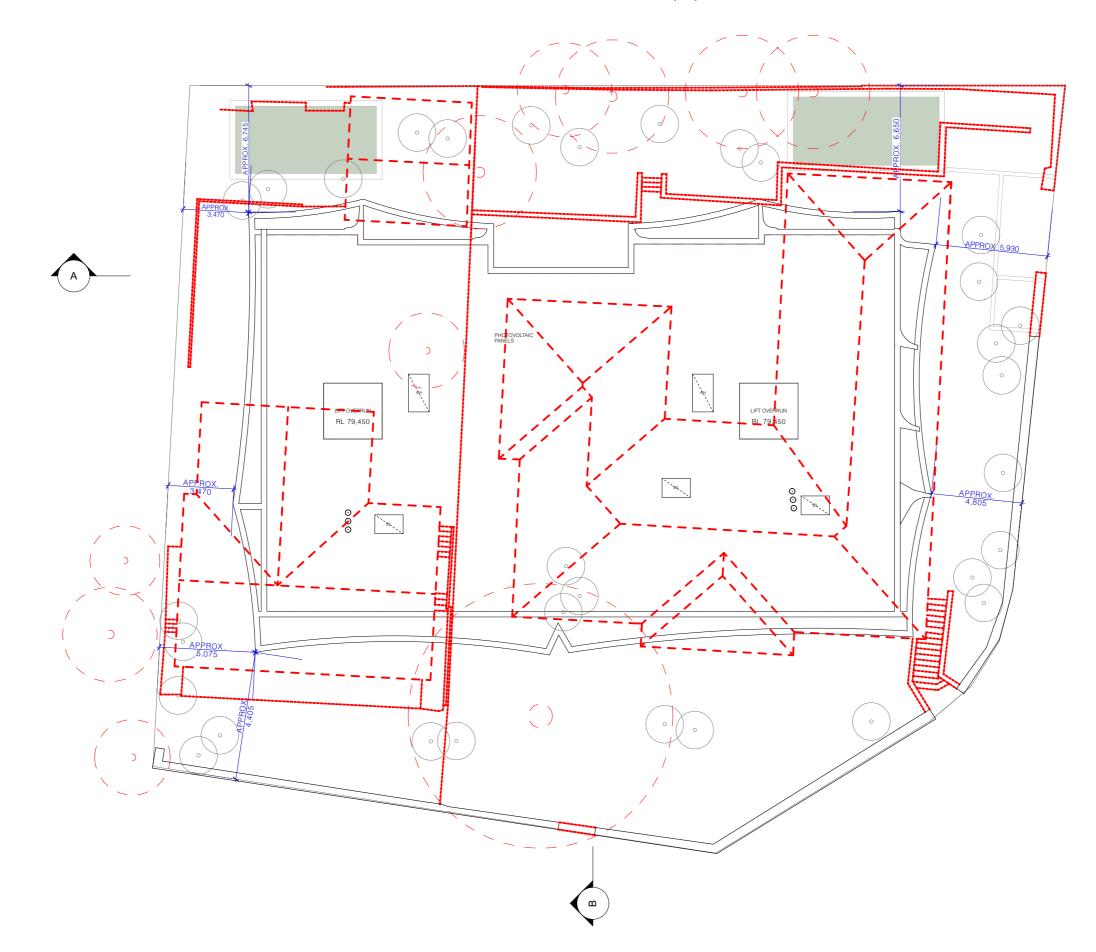




# LAND & ENVIRONMENT COURT NSW APPROVED

Date: 30 November 2022

DRAWING TITLE: ROOF PLAN PROJECT ADDRESS: 96-98 BEN BOYD RD, NEUTRAL BAY NSW 2089 APPLICANT: AIDOP NO 3 PTY LTD SUITE 506, LEVEL 5, 55 MILLER ST, PYRMONT NSW 2009




SCALE: DRAWN BY: CHECKED: 1:200@A3 ISSUE DATE: REVISION: 1/11/22 С PROJECT NUMBER: DWG NUMBER: 21-095 DA 2008 REF: BIN

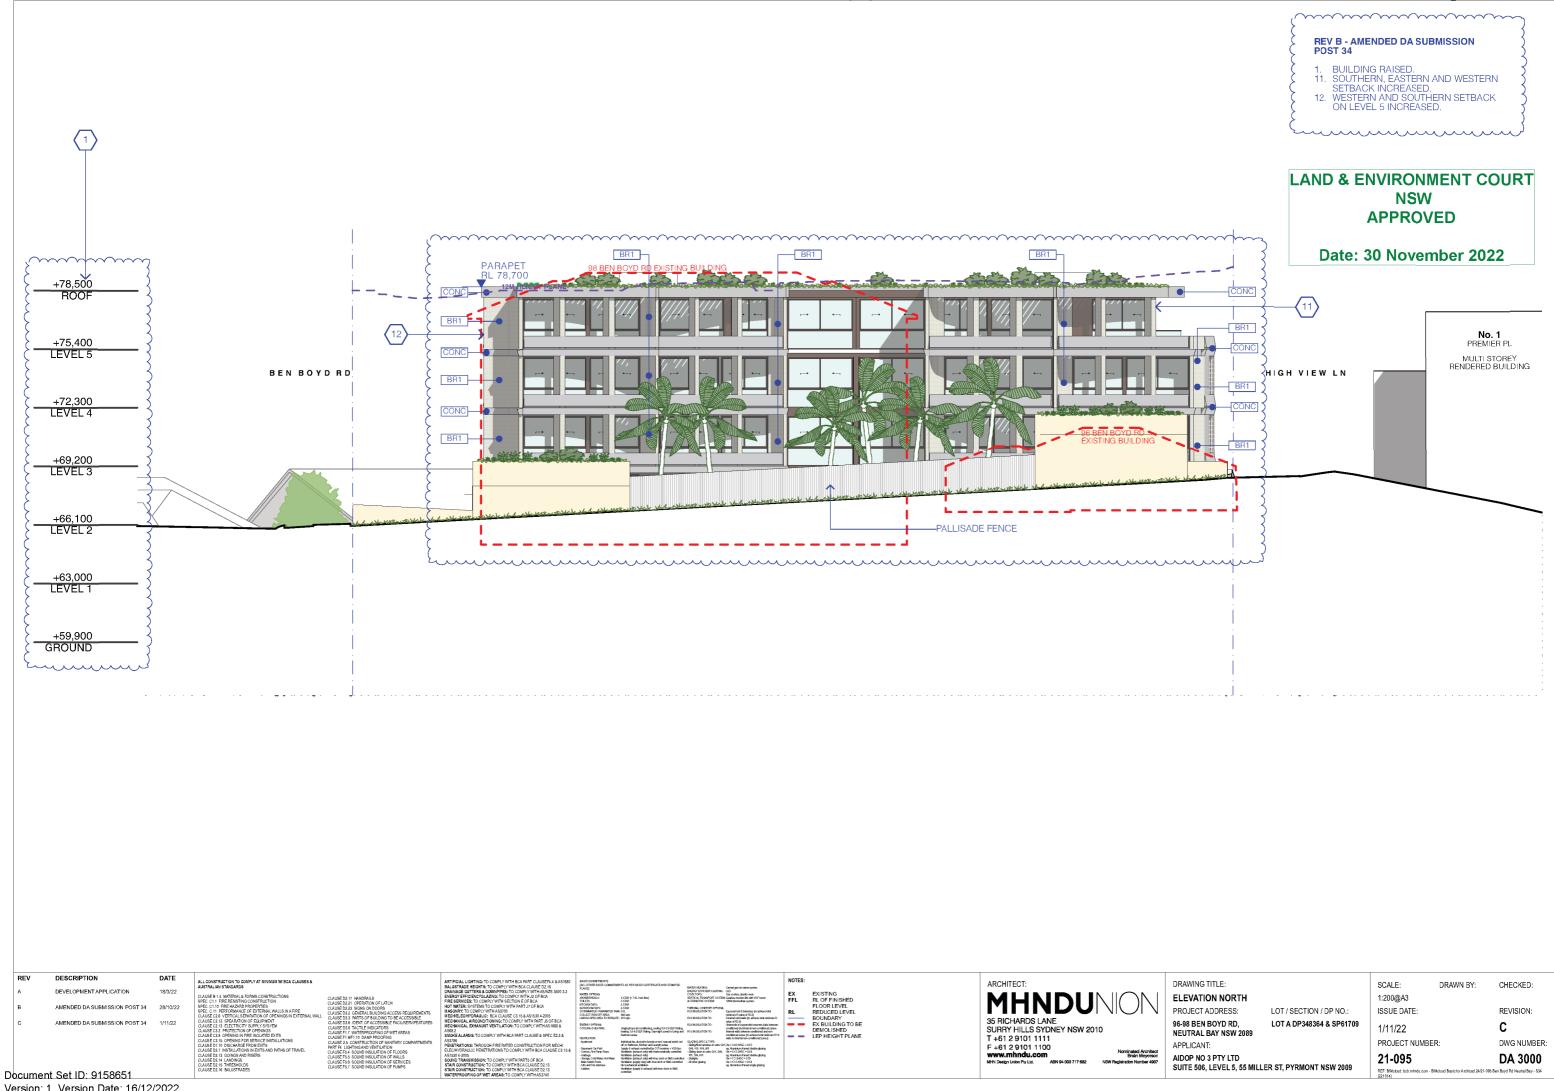

Version: 1, Version Date: 16/12/2022






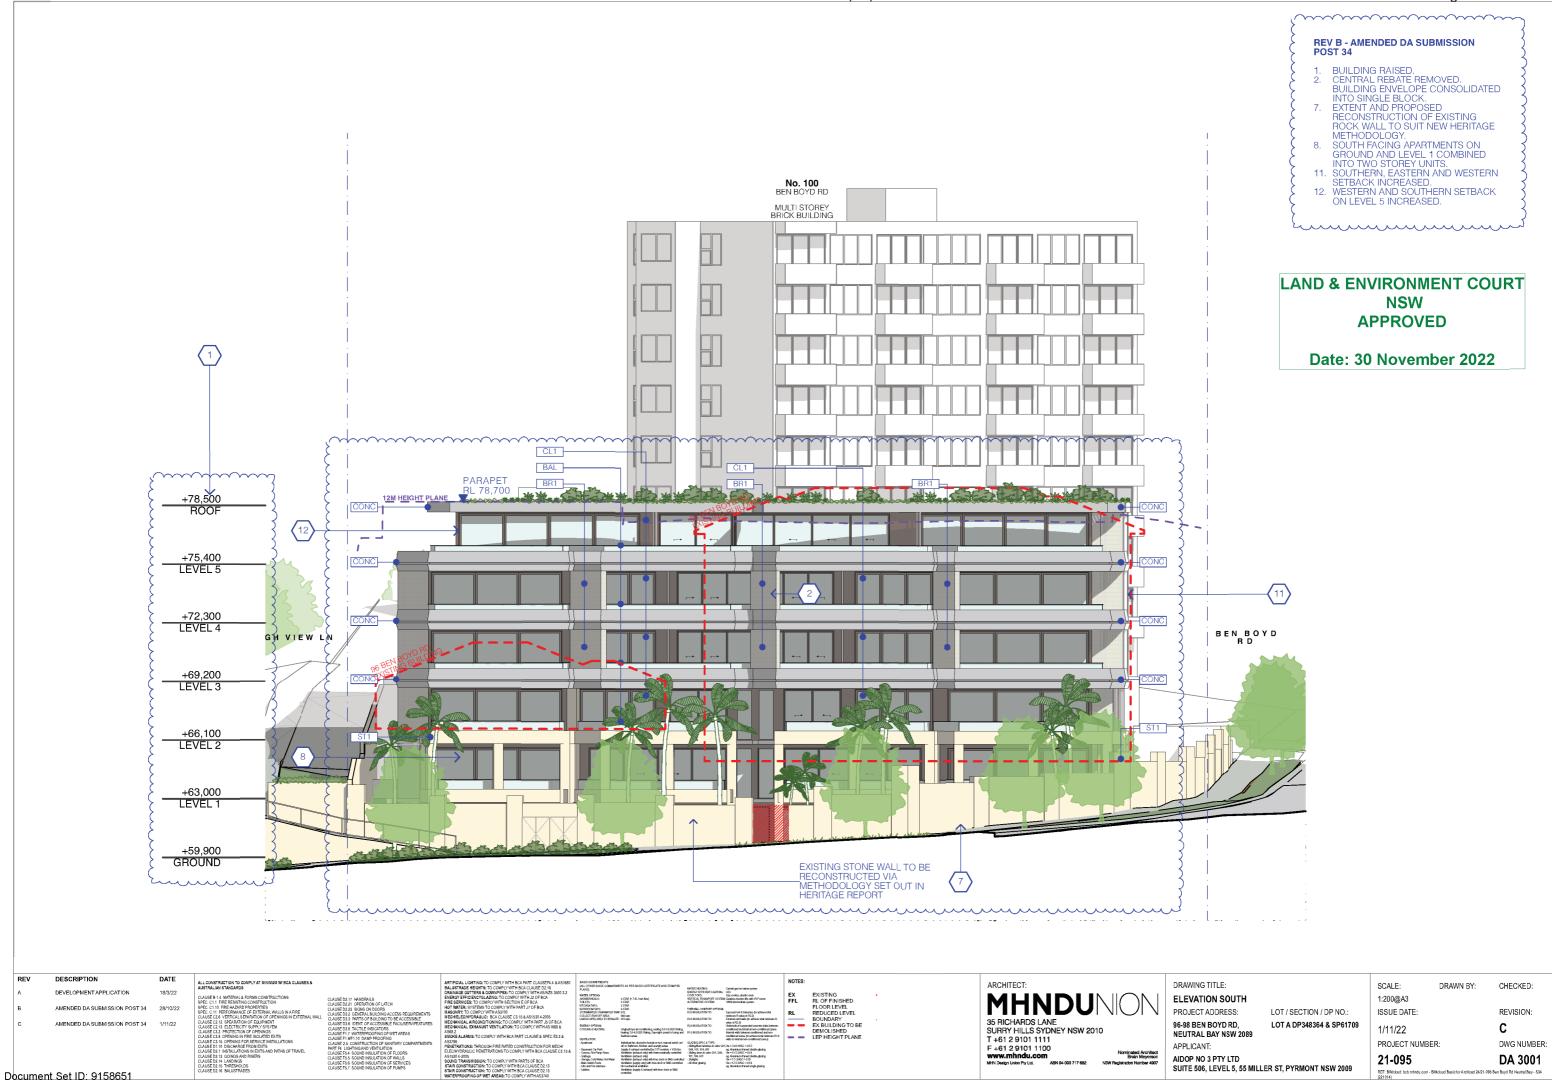


Version: 1, Version Date: 16/12/2022



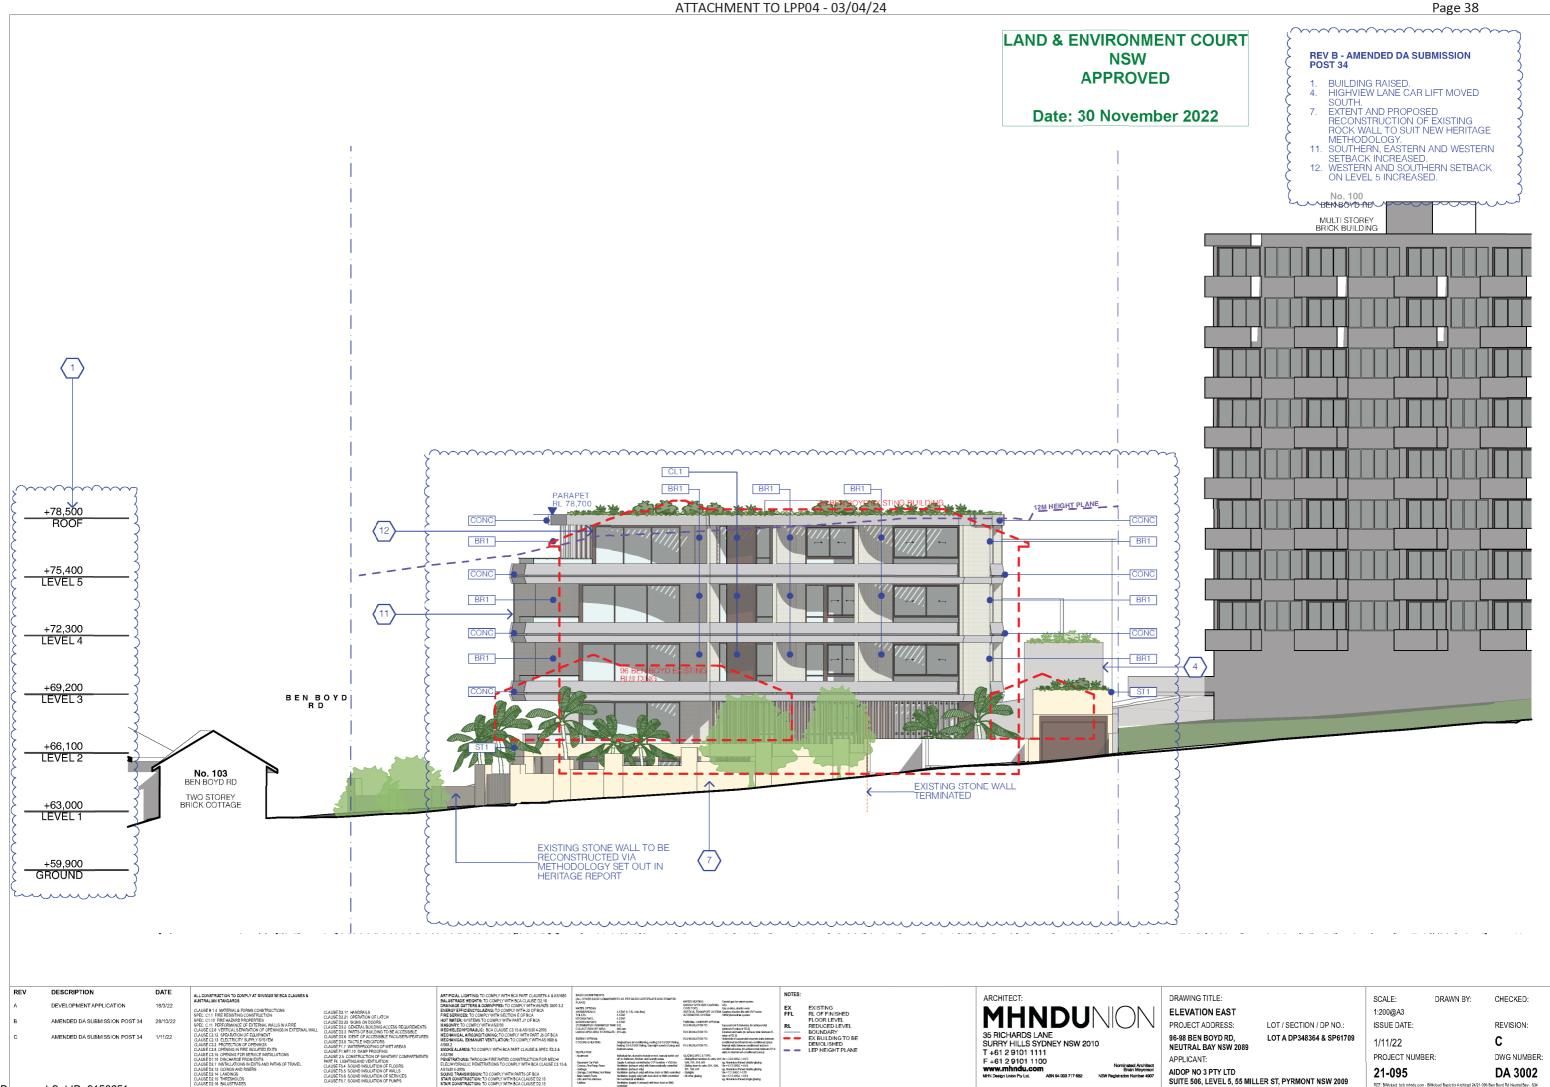


Document Set ID: 9158651 Version: 1, Version Date: 16/12/2022

# NSW

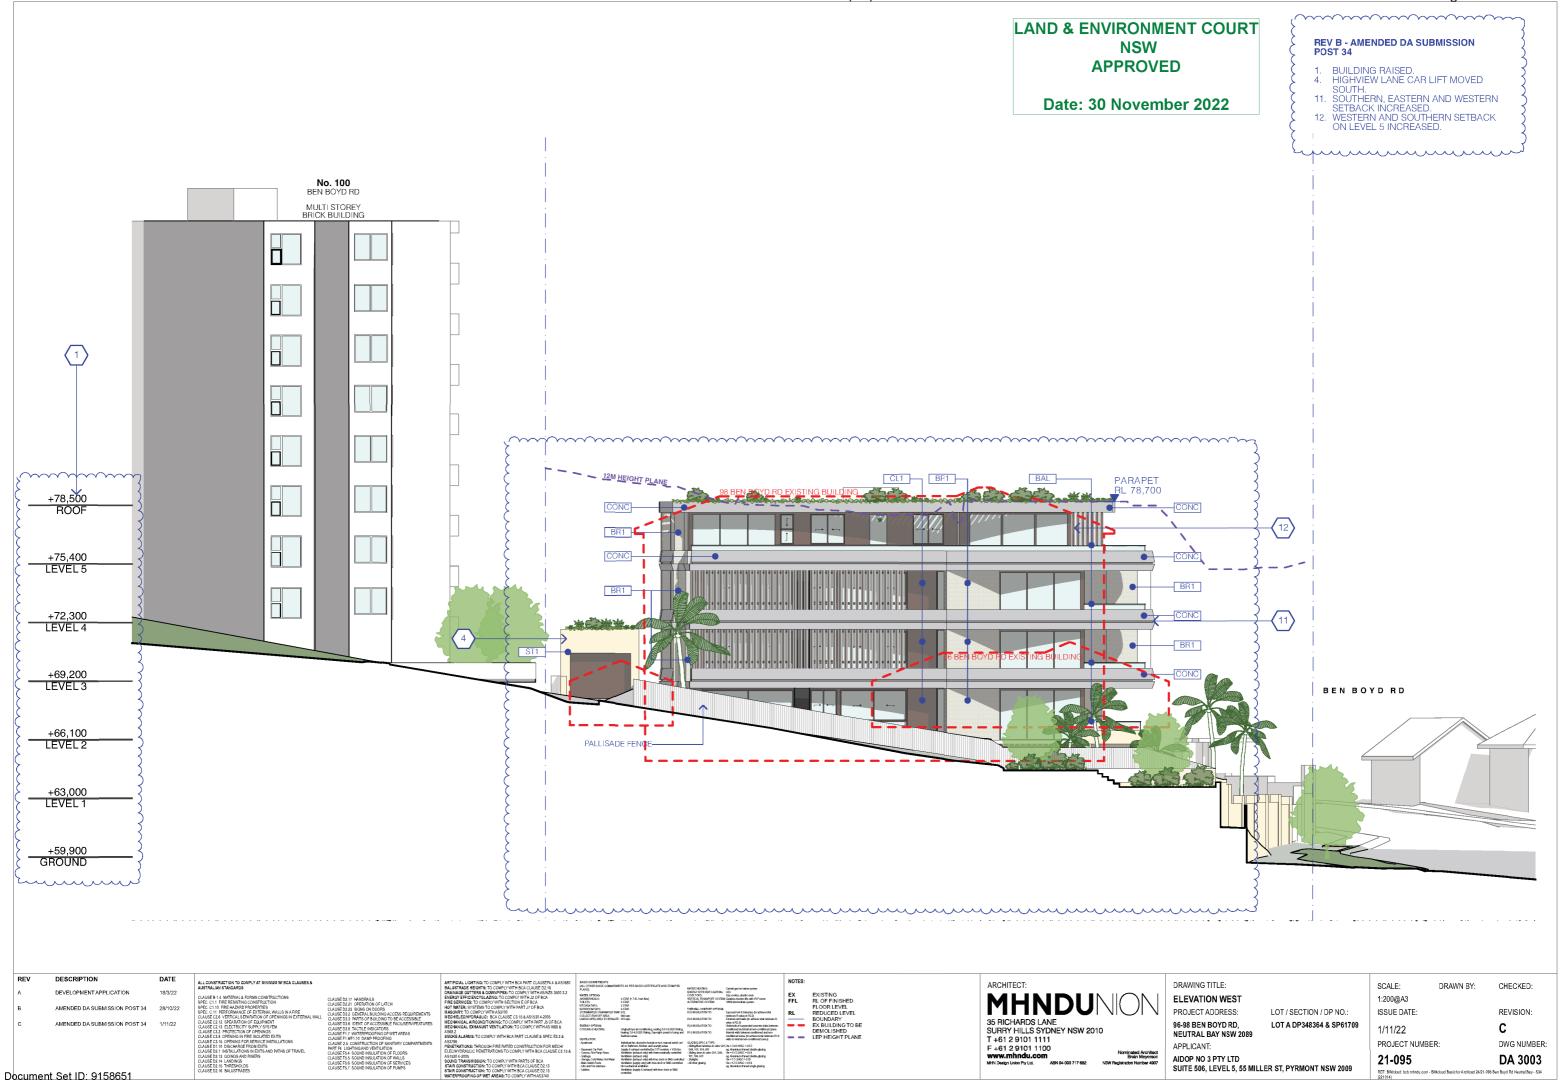

Version: 1, Version Date: 16/12/2022


ATTACHMENT TO LPP04 - 03/04/24

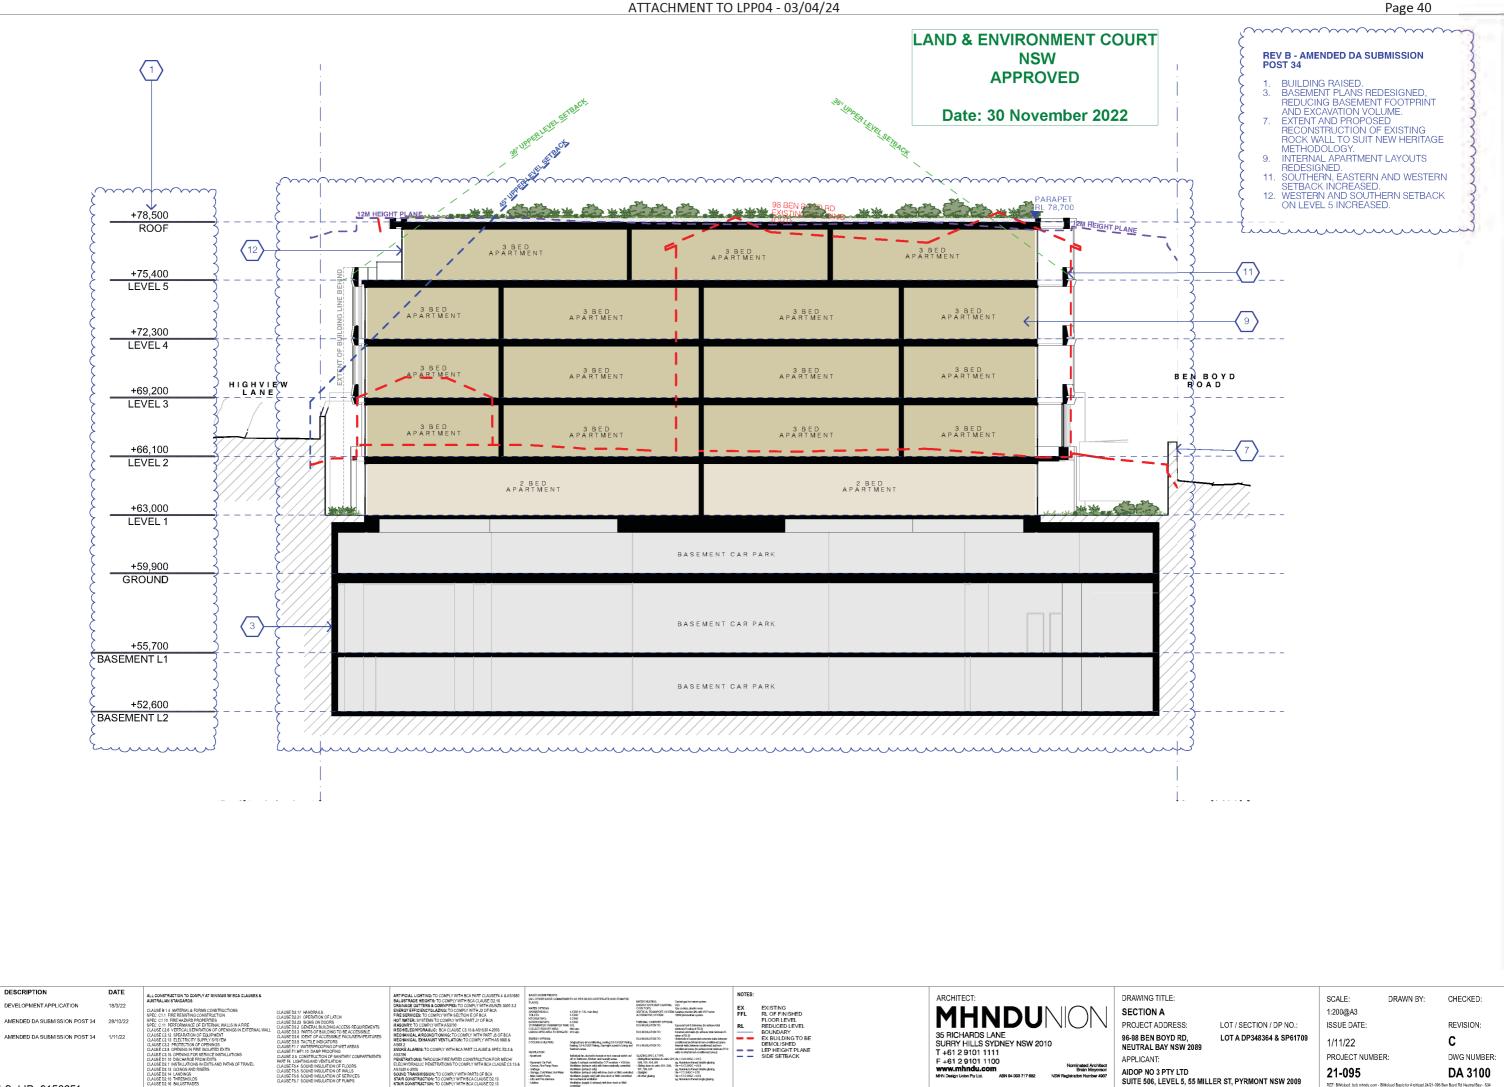


Document Set ID: 9158651 Version: 1, Version Date: 16/12/2022


DESCRIPTION

REV

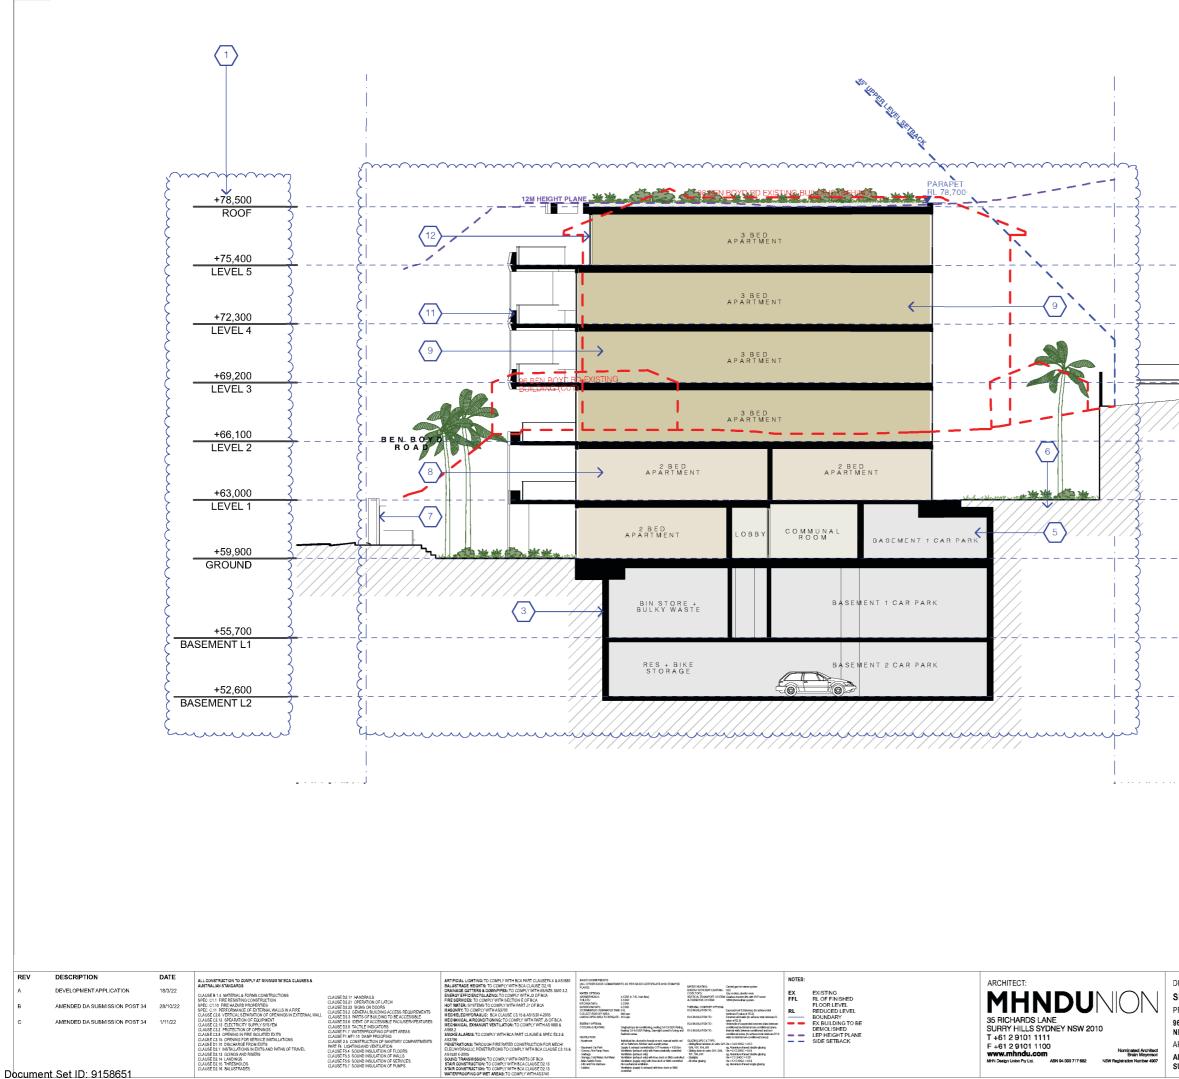

Version: 1, Version Date: 16/12/2022

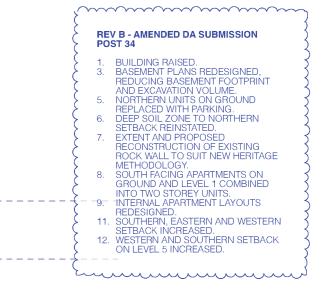

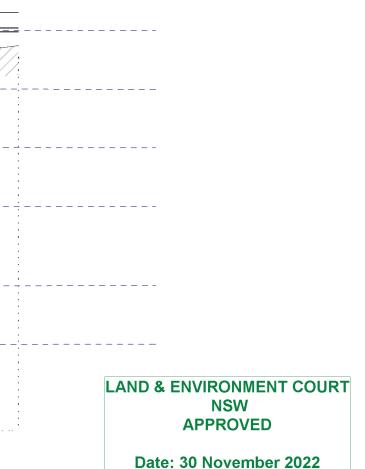

DRAWING TITLE: SECTION B PROJECT ADDRESS: 96-98 BEN BOYD RD, NEUTRAL BAY NSW 2089 APPLICANT: AIDOP NO 3 PTY LTD SUITE 506, LEVEL 5, 55 MILLER ST, PYRMONT NSW 2009

LOT / SECTION / DP NO .: LOT A DP348364 & SP61709 SCALE: 1:200@A3 DRAWN BY:

CHECKED:

ISSUE DATE:

1/11/22

PROJECT NUMBER: 21-095

REVISION: С


DWG NUMBER DA 3101





ST1 STONE BLOCKS, DRY PRESS JOINTS



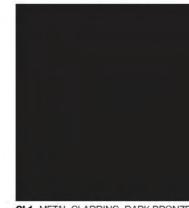

CL1 METAL CLADDING, DARK BRONZE





#### LAND & ENVIRONMENT COURT NSW **APPROVED**

······

#### Date: 30 November 2022



BAL GLASS BALUSTRADE, CAPTURED IN TOP RAIL, COLOUR TO MATCH C1

DRAWING TITLE: EXTERNAL FINISHES 01 PROJECT ADDRESS: 96-98 BEN BOYD RD, NEUTRAL BAY NSW 2089 AIDOP NO 3 PTY LTD SUITE 506, LEVEL 5, 55 MILLER ST, PYRMONT NSW 2009

LOT / SECTION / DP NO .: LOT A DP348364 & SP61709 1:1, 1:200, 1:4.26, 15536@ATE: 1/11/22

DRAWN BY:

CHECKED:

REVISION: С


DWG NUMBER:


PROJECT NUMBER:

21-095


SCALE:

DA 6000

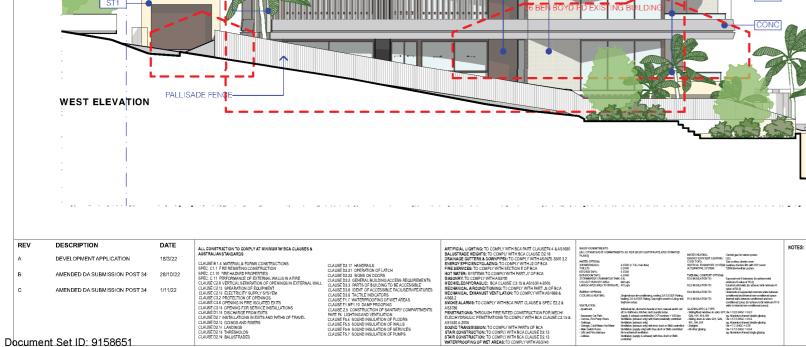

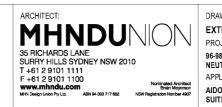



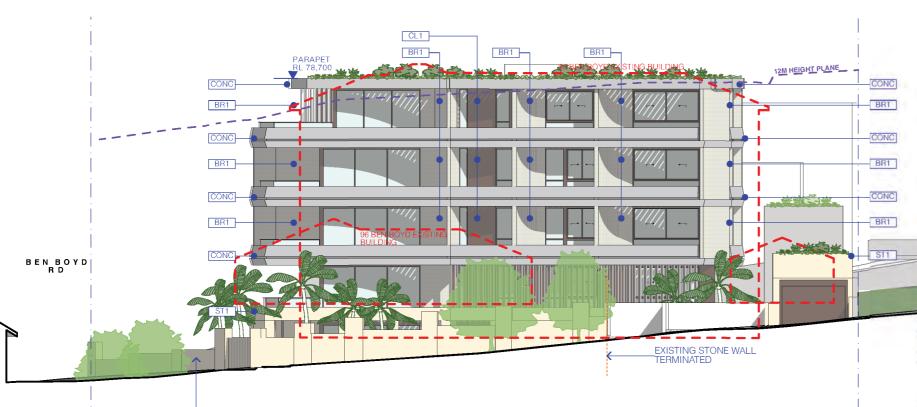



······

#### LAND & ENVIRONMENT COURT NSW **APPROVED**

#### Date: 30 November 2022





BAL GLASS BALUSTRADE, CAPTURED IN TOP RAIL, COLOUR TO MATCH C1

DRAWING TITLE: EXTERNAL FINISHES 02 PROJECT ADDRESS: 96-98 BEN BOYD RD, NEUTRAL BAY NSW 2089 APPLICANT: AIDOP NO 3 PTY LTD SUITE 506, LEVEL 5, 55 MILLER ST, PYRMONT NSW 2009

LOT / SECTION / DP NO .: LOT A DP348364 & SP61709 1530200ATE: 1/11/22

1:1, 1:4.26, 1:4.36,

DRAWN BY:

PROJECT NUMBER:

21-095

SCALE:

REVISION:

CHECKED:

С DWG NUMBER: DA 6001

## **SEPP 65 - SOLAR & CROSS VENTILATION**

(	~~~~~~~~~~~~~~~~~~~~~~~~~~~~~~~~~~~~~~~	~~~~~~	<u>,</u>
C TOTAL UNITS 21			2
SOLAR ACCESS			3
\$ 9AM - 3PM	PROPOSED	CONTROL	1
2+ HR	15 (71%)	14.7 (70%)	
	2 (10%)	-	$\gamma \smile$
ζ <u>0</u> 0 HR	3 (14%)	3.15 (15%)	3
8AM - 4PM	PROPOSED		3
> 0 2+ HR	18 (86%)		1
	1 (5%)		3
O 0 HR     O 1      O 1	3 (14%)		3
CROSS VENTILATION	N		5
{	PROPOSED	CONTROL	3
ACHIEVE	19 (90%)	12.6 (60%)	1
O NOT ACHIEVE	2 (10%)	-	3
hum	·····	·····	$\square$
,	~~~~~~~~~~~~~~~~~~~~~~~~~~~~~~~~~~~~~~~	~~~~~	لر
{			2
REV B - AMENDE	D DA SUBMISSI	ON POST	3
14. SOLAR & CRU		N	ξ.
	NS AMENDED.	N	2


### LAND & ENVIRONMENT COURT NSW **APPROVED**

······

Date: 30 November 2022





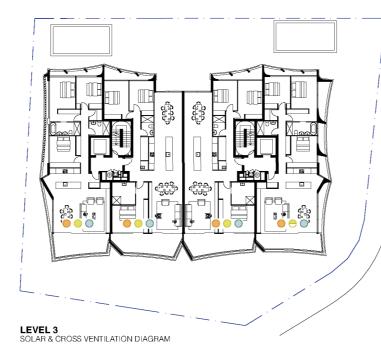



DESCRIPTION DATE CONSTRUCTION TO COMPLY AT MINIMUM W/ BCA CLAUSES TRALIAN STANDARDS REV NOTES: ARCHITECT: DEVELOPMENT APPLICATION 18/3/22 a coolege, electric over electration il to with AMENDED DA SUBMISSION POST 34 28/10/2 HER HALL COM 35 RICHARDS LANE SURRY HILLS SYDNEY NSW 2010 T +612 9101 1110 F +61 2 9101 1100 www.mhndu.com WH Despitation Fy Lia. ARtist-00377 682 N AMENDED DA SUBMISSION POST 34 Singlephase hunting 35-4 PART CLAUSE & SPEC E2.2 & NUTATION minated Archite Brian Meyera Document Set ID: 9158651 Version: 1, Version Date: 16/12/2022



## **SEPP 65 - STORAGE**

101 102 103	3 BED		IN UNIT	5
		10	V	-2
103	2 BED	8	$\checkmark$	3
100	2 BED	8	$\checkmark$	8-1
104	3 BED	10	$\checkmark$	3
105	2 BED	8	$\checkmark$	3
106	2 BED	8	✓	<b>ξ</b>
201	3 BED	10	$\checkmark$	3
202	3 BED	10	$\checkmark$	٦.
203	3 BED	10	$\checkmark$	3
204	3 BED	10	✓	}
301	3 BED	10	$\checkmark$	ξ.
302	3 BED	10	$\checkmark$	3
303	3 BED	10	$\checkmark$	ξ.
304	3 BED	10	✓	3
401	3 BED	10	$\checkmark$	2
402	3 BED	10	$\checkmark$	ξ.
403	3 BED	10	$\checkmark$	3
404	3 BED	10	$\checkmark$	ξ.
501	3 BED	10	$\checkmark$	3
502	3 BED	10	$\checkmark$	2
503	3 BED	10	$\checkmark$	3
504	3 BED	10	$\checkmark$	3
	·····	······		2

#### REV B SSION POST 34

13. LANDSCAPED AREA, SITE COVERAGE, STORAGE AREA CALCULATIONS AMENDED.

## LAND & ENVIRONMENT COURT **NSW APPROVED**

Date: 30 November 2022

STORAGI



DESCRIPTION DATE LL CONSTRUCTION TO COMPLY AT MINIMUM WIBCA CLAUSES & REV NOTES: ARCHITECT: MHNDUNON DRAWING TITLE: DEVELOPMENT APPLICATION 18/3/22 UNUE RECEIVE ENERGY EPIPCIENT LIG COOK TOPS: VERTICAL TRANSPORT : A TELEVISION SEPP 65 - STORAGE Gas codeg, decelor over Gasé aus tockin ilits with V AMENDED DA SUBMISSION POST 34 28/10/2 THERMAL CONT STATISTICS PROJECT ADDRESS: LOT / SECTION / DP NO .: 35 RICHARDS LANE SURRY HILLS SYDNEY NSW 2010 T +61 2 9101 1111 F +61 2 9101 1100 www.mhndu.com MH Deeptoinery La. ASI 94 000 717 692 NS 96-98 BEN BOYD RD, LOT A DP348364 & SP61709 AMENDED DA SUBMISSION POST 34 1/11/22 ENERGY OPTIONS CON INCLUSENTING CLAUSE D3. CLAUSE F1. CLAUSE F1. Singlephase si hunting 35-6.0 NEUTRAL BAY NSW 2089 H BCA PART CLAUSE & SPEC E2.2 & VERTILATION: - Apathesi  $(\mathcal{R})$ APPLICANT: - Seament Car Park - Connes, Rre-Parip R - Gatage - Serage, Cold Water, - Nain Switch Room - Uits switch Room - Uits switch Room - Luts solition ominated Archite Brian Meyerse AIDOP NO 3 PTY LTD SUITE 506, LEVEL 5, 55 MILLER ST, PYRMONT NSW 2009 Document Set ID: 9158651

SCALE: 1:500, 1:1@A3 ISSUE DATE:

1/11/22 PROJECT NUMBER:

21-095

REF: BI



С










STORAGE

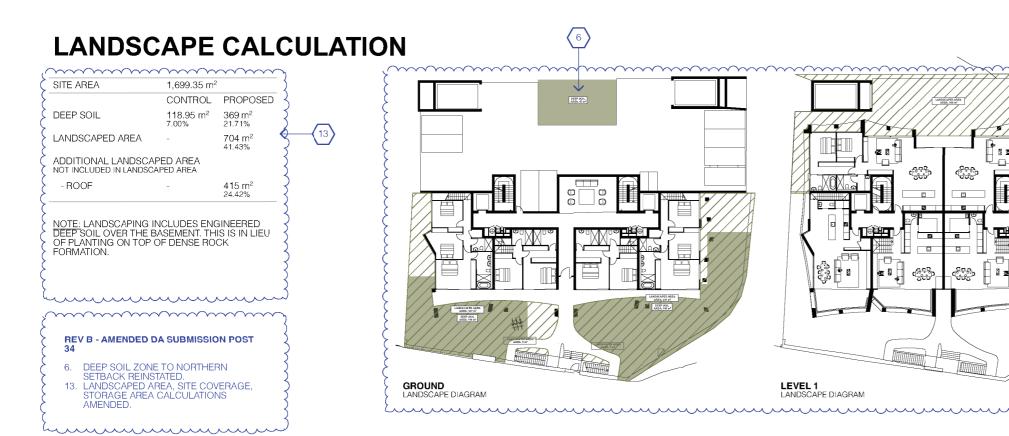


LAND & ENVIRONMENT COURT NSW **APPROVED** 

Date: 30 November 2022



#### Page 46

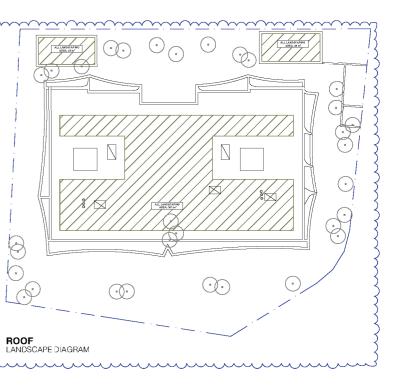

DRAWING TITLE:

 $\sim$ 

للهجا

D G

2

#### LANDSCAPE CALCULATION

PROJECT ADDRESS: 96-98 BEN BOYD RD, NEUTRAL BAY NSW 2089



SCALE: DRAWN BY: 1:500, 1:250, 1:1@A3 ISSUE DATE:

1/11/22

21-095

CHECKED: REVISION:

PROJECT NUMBER:

С DWG NUMBER: DA 9102


AIDOP NO 3 PTY LTD SUITE 506, LEVEL 5, 55 MILLER ST, PYRMONT NSW 2009

#### LAND & ENVIRONMENT COURT NSW **APPROVED**

## SITE COVERAGE DIAGRAM

SITE AREA	1,699.35 m <sup>2</sup>	
	CONTROL	PROPOSED
SITE COVERAGE	764.71 m² 45.00%	825 m <sup>2</sup> 48.55%
JNBUILT AREA	254.90 m <sup>2</sup> 15.00%	462 m <sup>2</sup> 27.54%



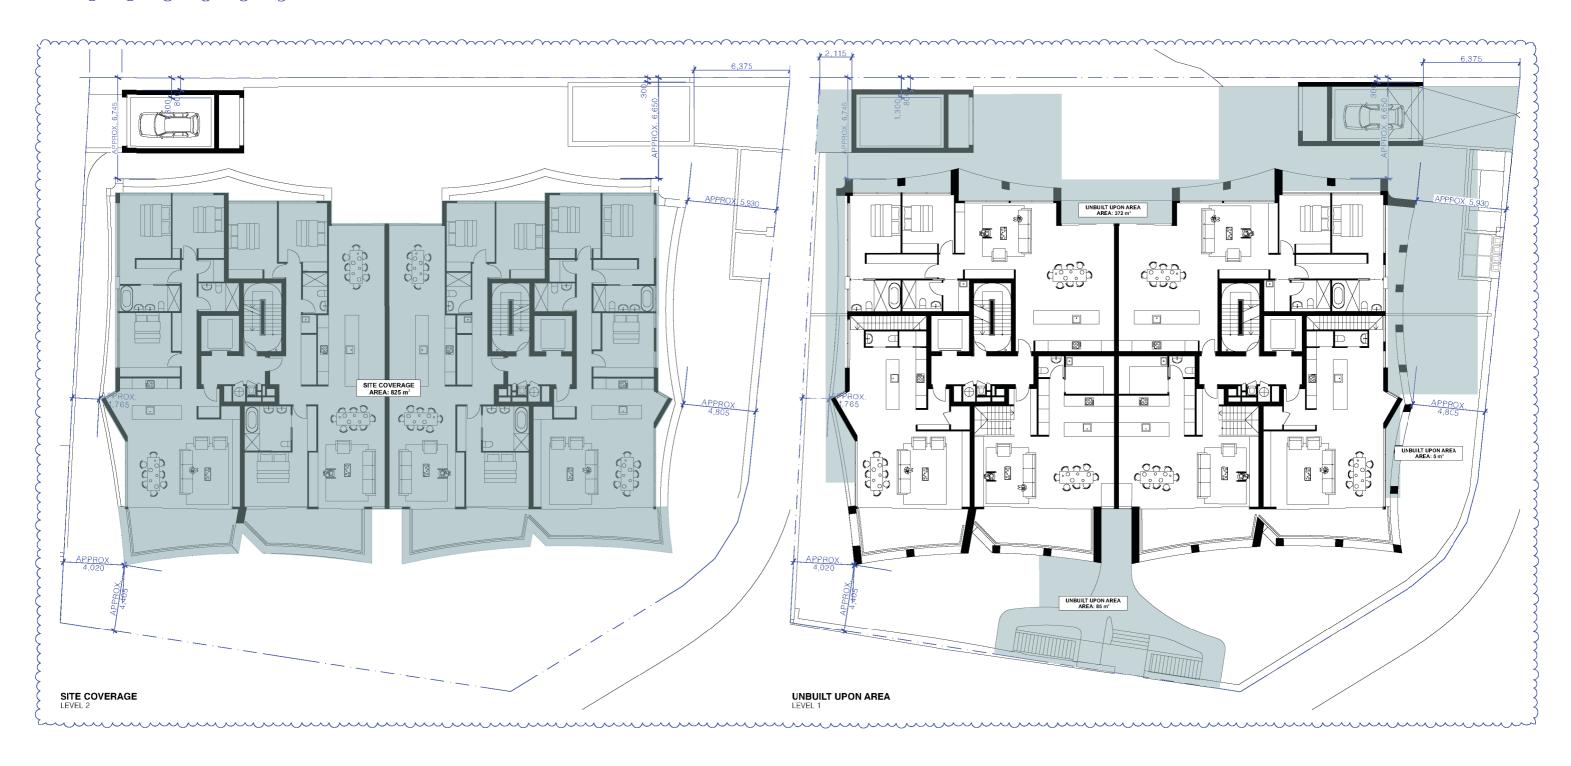





REV B - AMENDED DA SUBMISSION POST 34 13. LANDSCAPED AREA, SITE COVERAGE, STORAGE AREA CALCULATIONS AMENDED. 

DRAWING TITLE:

#### SITE COVERAGE DIAGRAM

PROJECT ADDRESS: 96-98 BEN BOYD RD, NEUTRAL BAY NSW 2089



SCALE: DRAWN BY: 1:347.22, 1:250@A3 ISSUE DATE:

CHECKED:

REVISION:

С DWG NUMBER: DA 9103

SUITE 506, LEVEL 5, 55 MILLER ST, PYRMONT NSW 2009


21-095 REF: BIN

1/11/22

PROJECT NUMBER:



S34 ENVELOPE -

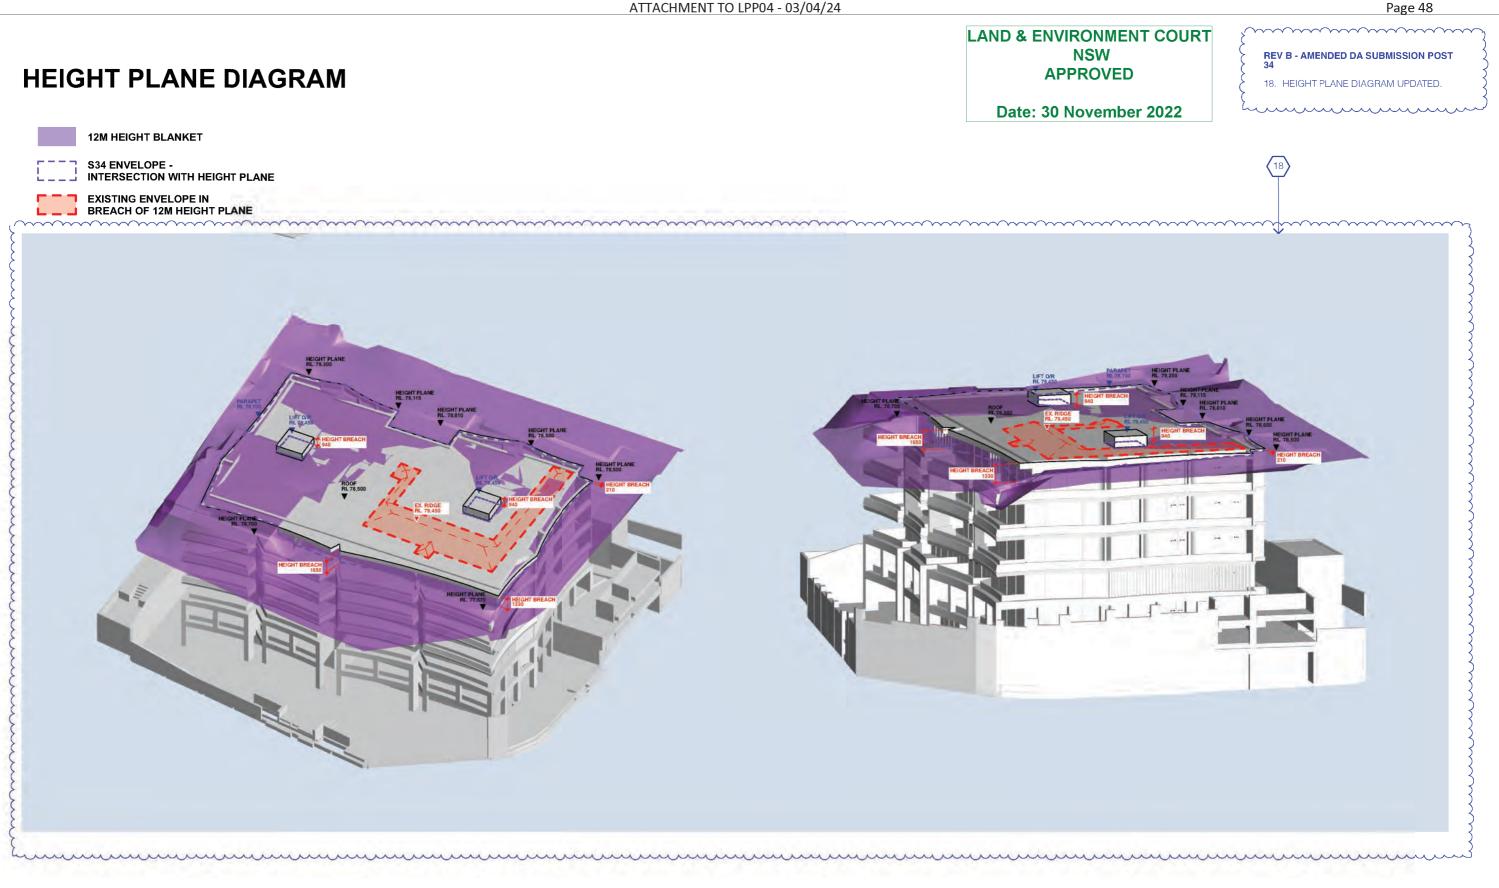



DRAWING TITLE: HEIGHT PLANE DIAGRAM PROJECT ADDRESS: LOT / SECTION / DP NO .: 96-98 BEN BOYD RD, LOT A DP348364 & SP61709 NEUTRAL BAY NSW 2089 AIDOP NO 3 PTY LTD SUITE 506, LEVEL 5, 55 MILLER ST, PYRMONT NSW 2009

SCALE: DRAWN BY: 1:2.78, 1:277.78@A3

CHECKED:

ISSUE DATE:

1/11/22 PROJECT NUMBER:

21-095

REVISION:


С DWG NUMBER: DA 9104

## WASTE MANAGEMENT PLAN





#### ATTACHMENT TO LPP04 - 03/04/24

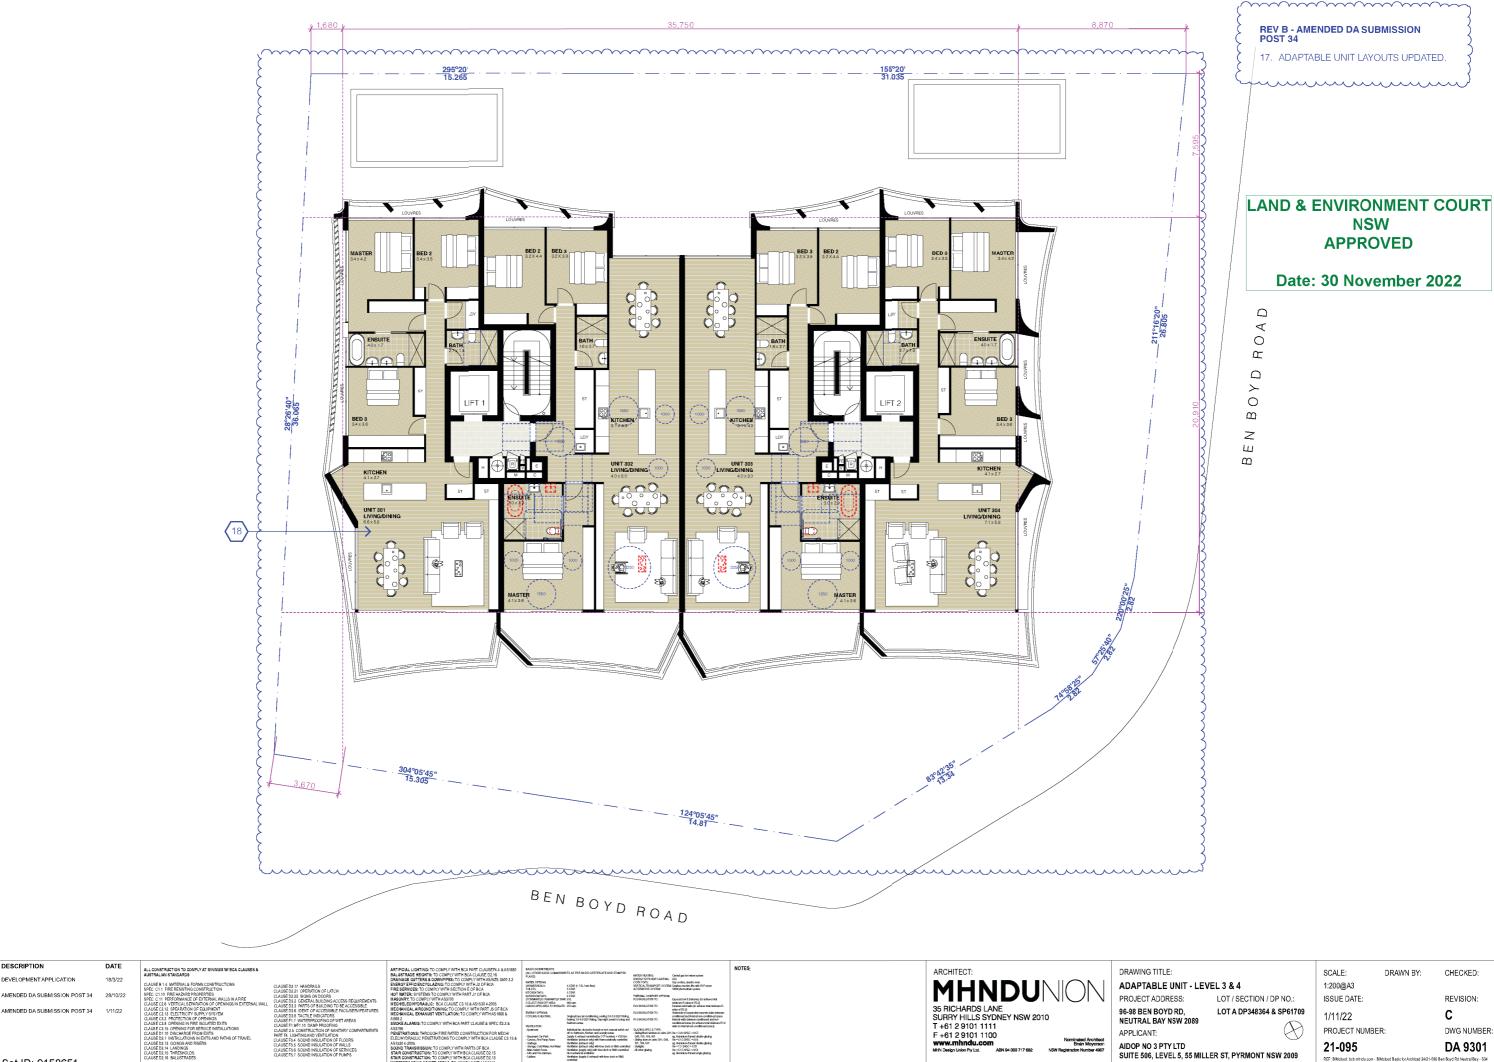

Document Set ID: 9158651 Version: 1, Version Date: 16/12/2022

DESCRIPTION

DEVELOPMENT APPLICATION

REV

REF: BI)

# **Concepts** | Landscape Plan

LAND & ENVIRONMENT COURT HMENT TO LPP04 - 03/04/24 NSW APPROVED

0

00

### Date: 30 November 2022

High View Lane

00

47

#### LEGEND

01 Existing public domain retained / made good as required

02 Retention and re-use of existing sandstone wall on site boundary

03 Existing ramp and balustrade to be refurbished

04 Salvaged sandstone block wall to be reinstated as raised viewing platform with turf and planting and bench seating oriented to city views to improve public amenity

05 Entry courtyard with stair and platform lift access to street 06 Exposed sandstone bedrock


06 Large native evergreen tree in deep soil

07 Medium native evergreen trees to deep soil adjacent Ben Boyd Road to soften built form from public domain and to provide shade canopy coverage

08 Private courtyards recessed into lush sandstone gully planting

09 Palm planting to complement canopy tree planting and provide additional screening and green outlook to upper floor apartments



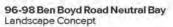

Premier Street

1:200 @ A3



0

3

00

52

s. 2 BenBoydRoad

Page 51

Date Issue October 2022 D

## **Concepts** | Entry Forecourt

#### LEGEND

01 Existing public domain retained / made good as required

02 Retention and re-use of existing sandstone wall on site boundary

03 Secure gated entrance from Ben Boyd Road

04 Platform lift

05 Carved sandstone 'shard' and stair

06 Medium native evergreen trees to deep soil adjacent Ben Boyd Road to soften built form from public domain and to provide shade canopy coverage

07 Private courtyards

08 Garden beds typically 1000mm depth (1500mm depth for trees) over structural slab /bedrock provide separation between private courtyards and communal spaces, punctuated with large bush rock accents

09 Generous private courtyards provide solar access to ground floor units, recessed into lush sandstone gully planting

10 Palm planting to complement canopy tree planting and provide additional screening and green outlook to upper floor apartments

ARCADIA Document Set ID: 9158651 Version: 1, Version Date: 16/12/2022



2

Ben Boyd Road

1:100 @ A3

2

52




Date Issue October 2022 D

## **Concepts** | Entry Forecourt





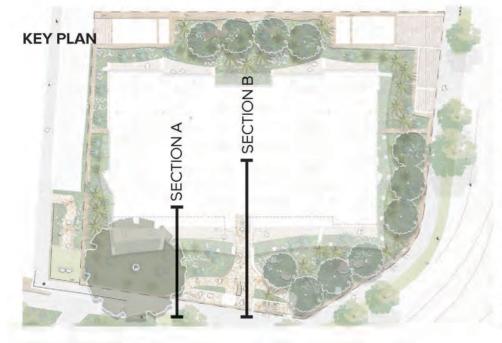

#### LEGEND

01 Existing public domain retained / made good as required

02 Retention and re-use of existing sandstone wall on site boundary

03 Fire egress from basement

04 Stair integrated into salvaged sandstone 'shard'

05 Stone paving to entrance forecourt

06 Garden beds typically 1000mm depth over structural slab/ bedrock with lush sandstone gully planting provide separation between private courtyards and communal spaces. Mounding to 1500mm depth for trees.

canopy coverage



96-98 Ben Boyd Road Neutral Bay Landscape Concept

1:100 @ A3


Prepared By Arcadia Landscape Architecture Aidop No.3 Ptv Ltd

Page 53

#### 07 Palm planting to complement canopy tree planting and provide additional screening and green outlook to upper floor apartments

#### 08 Medium native evergreen trees to deep soil adjacent Ben Boyd Road to soften built form from public domain and to provide shade


## **Concepts** | Private Courtyards

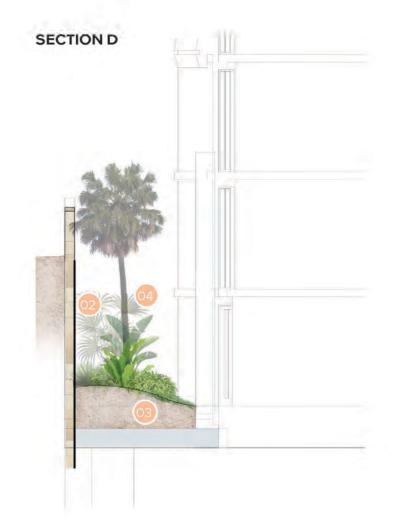







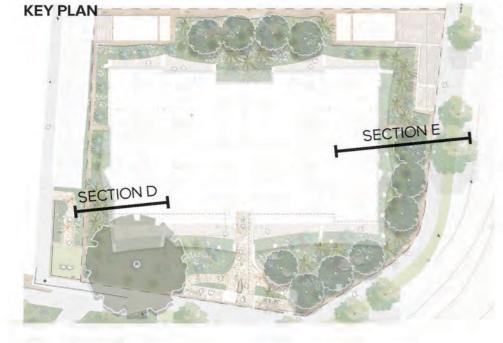

#### LEGEND

01 Retention and re-use of existing sandstone wall on site boundary

02 Exposed sandstone bedrock with quarried finish, rock planting to colonise face

03 Garden beds typically 1000mm depth over structural slab / bedrock with lush sandstone gully planting. Mounding to 1500mm depth for trees.

04 Palm planting to complement canopy tree planting and provide additional screening and green outlook to upper floor apartments





96-98 Ben Boyd Road Neutral Bay Landscape Concept

1:100 @ A3





Page 54



Date Issue October 2022 D

24

## **Concepts** | Private Courtyards






## LEGEND

01 Medium native evergreen trees to soften built form from external viewpoints and to provide shade canopy coverage

02 Exposed sandstone bedrock with quarried finish, rock planting to colonise face

03 Garden beds typically 1000mm depth over structural slab / bedrock with lush sandstone gully planting. Mounding to 1500mm depth for trees.

04 Rear stone paved courtyards provide private outdoor amenity to ground floor units set amongst a unique 'Sandstone Gully' ecotone showcasing locally endemic species against the backdrop of the quarried sandstone wall

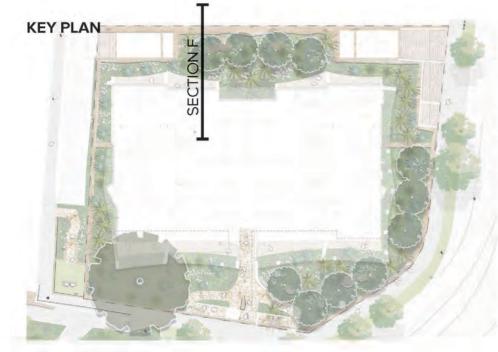



96-98 Ben Boyd Road Neutral Bay Landscape Concept

1:100 @ A3





## **Concepts** | Sandstone Edge Conditions

#### EXCAVATED ROCK FACE

The exposed sandstone of the proposed site excavation provides an opportunity to express the 'bones' of the site and create a unique micro-climatic experience for residents and visitors.


The final appearance of the sandstone faces will be dependent on geotechnical investigations, however if the sandstone is of acceptable standard then several typologies are possible. These are illustrated on this page.

#### **TYPE A - NATURAL**

Qaurried and worked face requiring specialist stonemasonry tooling and finishing, to replicate more naturalistic undulating forms in the rock. Potentially seeded with pioneering plants.





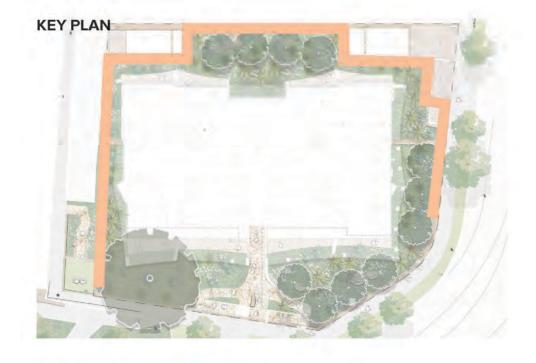

#### **TYPE B - TERRACED**

Quarried face with stepped or terraced layers, which could be used to integrate planting to scramble down the face of the rock.





#### **TYPE C - VERTICAL QUARRIED**

Quarried face with straight vertical cut, ideal for more space constrained edges where solar access and setback is to be prioritised.













Date Issue October 2022 D

26

## **Concepts** | Rooftop Planting

#### LEGEND

01 Extensive irrigated rooftop garden to car elevator roofs - maintenance access only. 150mm soil depth extensive roof garden 'Junglefy Green Roof' or similar

02 Extensive irrigated rooftop garden to building rooftop maintenance access only

03 Roof hatch for maintenance access


04 Stabilised pebble ballast maintence access path around perimeter of rooftop, with integrated anchor points





Premier Street




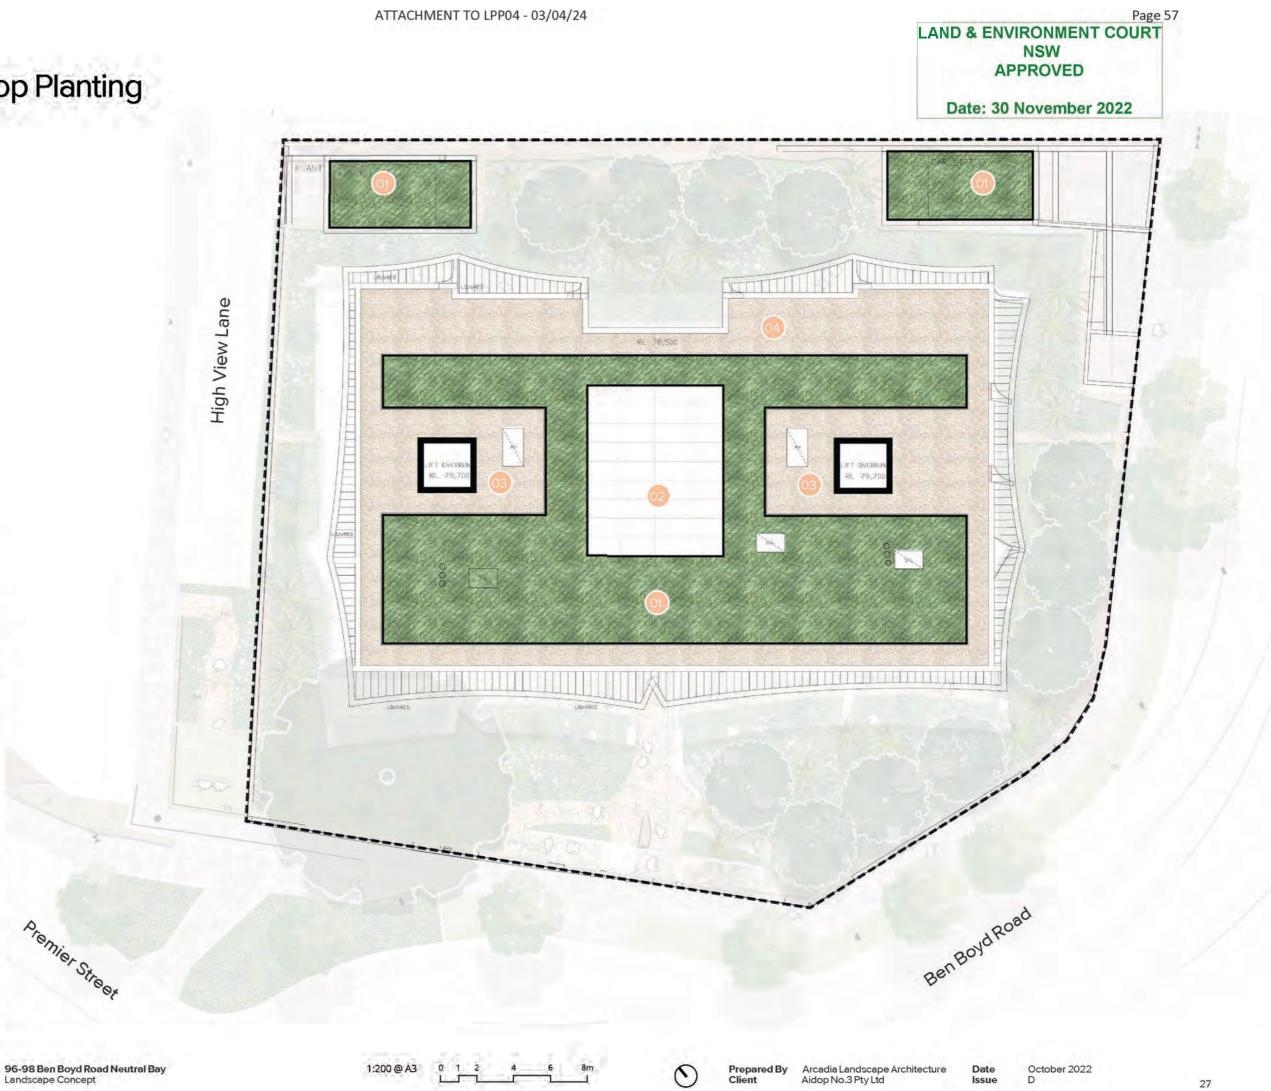

ATTACHMENT TO LPP04 - 03/04/24

## Landscape Areas



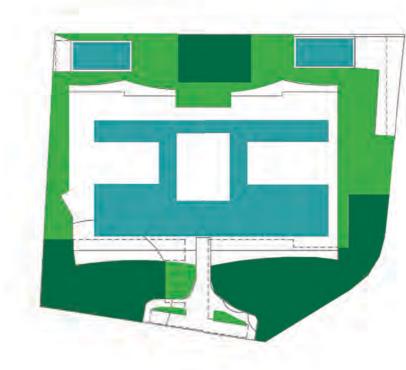



#### TREE LAYER



Palms

Deep Soil Zone (excludes basement, building footprint, and landscape hard pavements)\*

\*In most areas there are dense rock formations present within the proposed deep soil zone. We propose excavating down as required to build up to 1500mm depth of engineered deep soil to support canopy trees, palms, and layered understorey vegetation, in alignment with industry best practice.

#### SOFT LANDSCAPE LAYER

- - Soft Landscape on Deep Soil/Engineered Deep Soil\* 1000-1500mm soil depth 369m2 (22%)
  - Soft Landscape on Podium + Engineered deep soil\* 1000-1500mm soil depth 336m2 (20%)

Total Soft Landscape Area at ground level: 705m2 (41% of total site area)

Additionally:



Planting on Rooftop 150mm soil depth extensive roof garden 'Junglefy Green Roof' or similar 350m2 (20%)

#### **OPEN SPACE PROGRAM**



Paved Private Open Space

78m2



62m2

Total Hard Paved Landscape Area at ground level: 210m2 (12% of total site area)



Paved Communal Open Space (accessible)


Paved Driveways / Utility Spaces

ATTACHMENT TO LPP04 - 03/04/24

## **Canopy Cover**



1 1

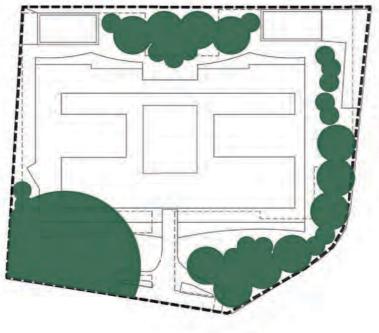

#### **EXISTING CANOPY COVER**



Site Area - 1700m2

Existing Tree Canopy Area - 370m2 (22% of site area)

#### PROPOSED CANOPY COVER



Site Area - 1700m2

Proposed Tree Canopy Area - 463m2 (27% of site area)


#### NOTE:

Assumes at maturity -Large tree 20m diameter equal to Angophora costata, Medium tree 5m diameter equal to Cupaniopsis anacardioides Palm tree 2.5m diameter equal to Livistona australis



#### LAND & ENVIRONMENT COURT NSW **APPROVED**


## Design Strategies | Material Look and Feel

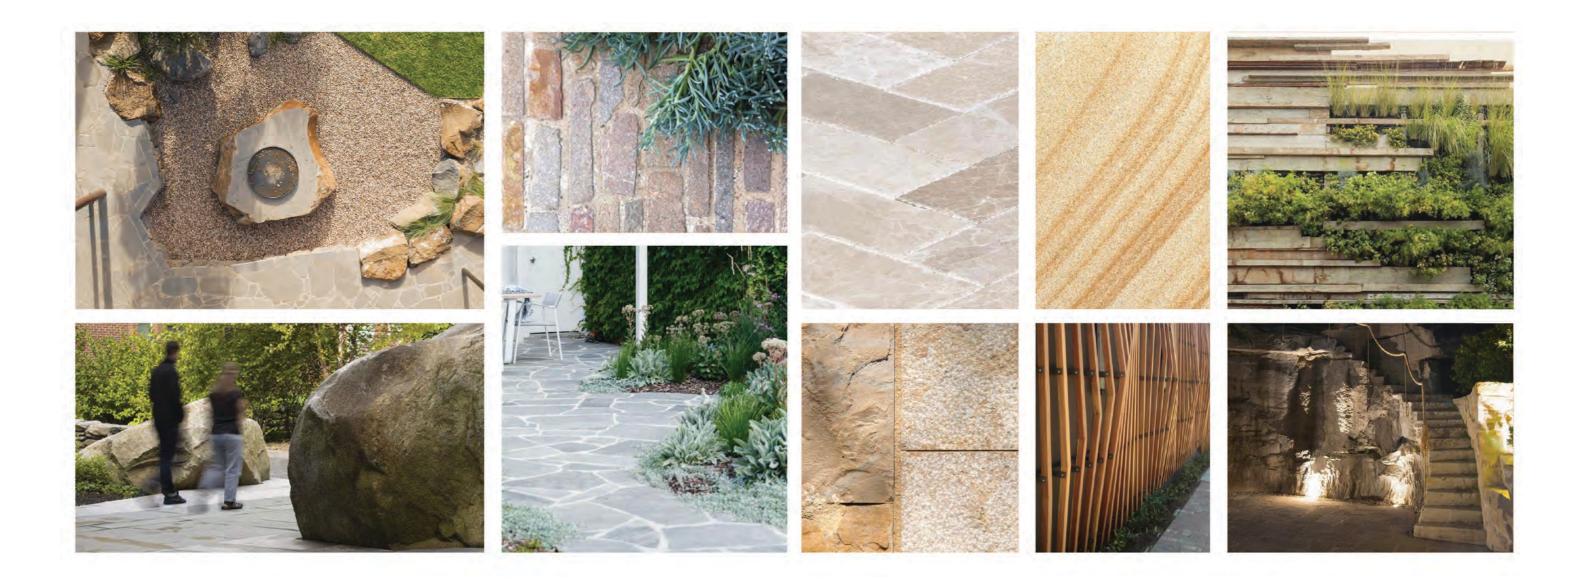



#### LAND & ENVIRONMENT COURT NSW APPROVED


## Design Strategies I Indicative Lighting Strategy

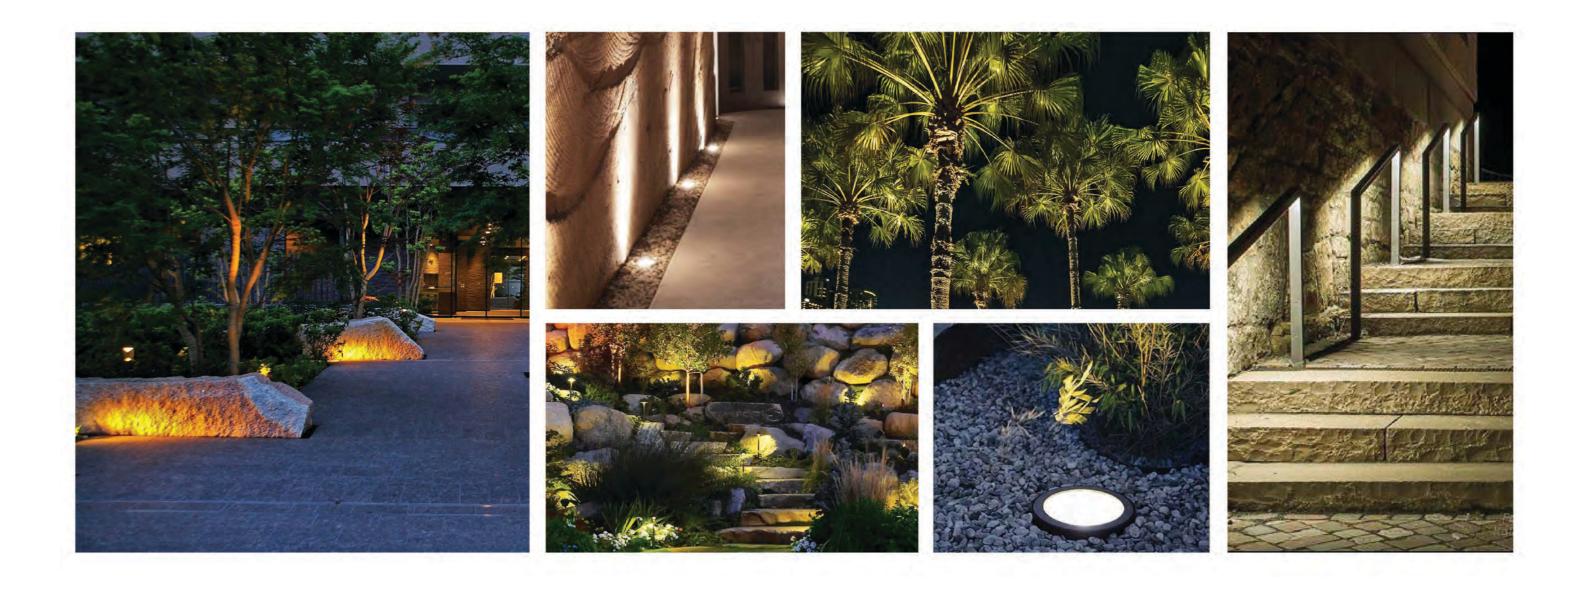



### LAND & ENVIRONMENT COURT NSW APPROVED

## Design Strategies | Planting Look and Feel

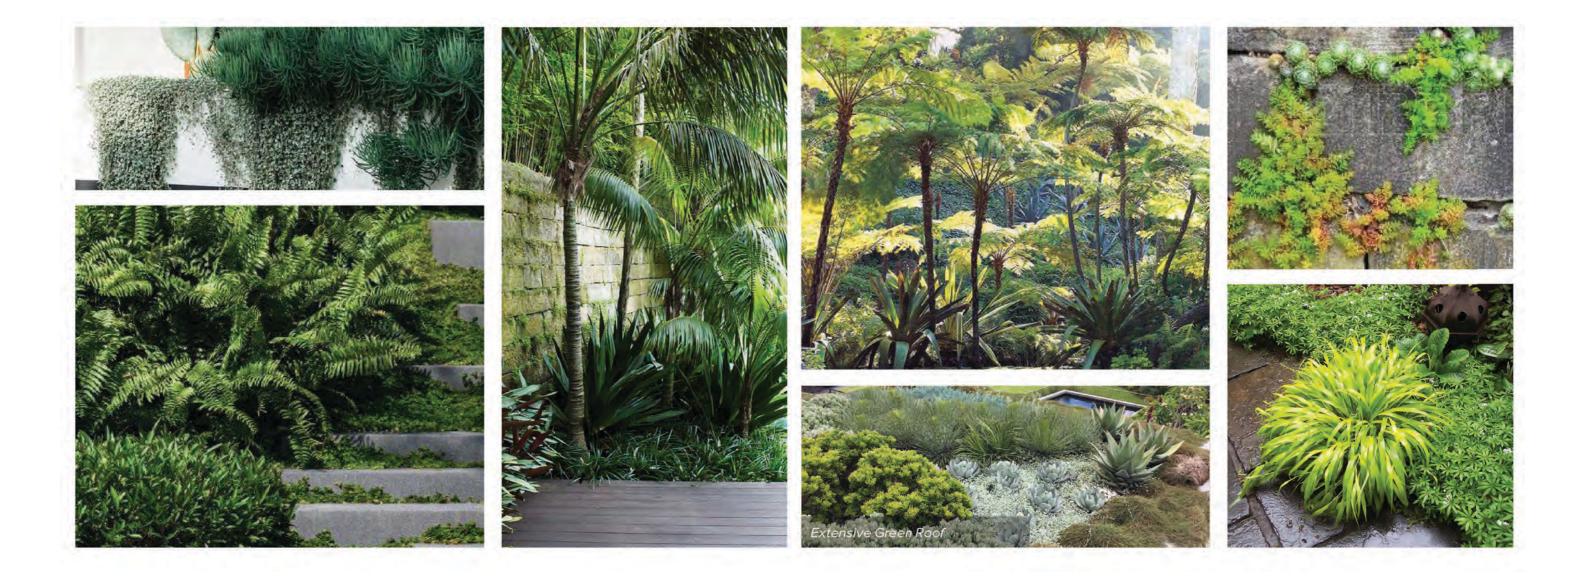



## **Design Strategies** | Planting Palette



ARCADIA Document Set ID: 9158651 Version: 1, Version Date: 16/12/2022

96-98 Ben Boyd Road Neutral Bay Landscape Concept

 Prepared By
 Arcadia Landscape Architecture

 Client
 Aidop No.3 Pty Ltd



Date Issue October 2022 D

## Design Strategies | Planting Schedule

## 21-805 96-98 BEN BOYD ROAD PLANT SCHEDULE

CODE	BOTANIC NAME	COMMON NAME	MATURE SIZE (h x w) (m)	PROPOSED POT SIZE	DENSITY
ANDST	ONE GULLY - GROUND LEVEL				
	TREES				
Ac	Angophora costata	Smooth Barked Apple	25 x 10	Min 1m trunk	As Shown
ΤI	Tristaniopsis laurina	Water Gum	10 x 6	Min 2m trunk	As Shown
La (6m)	Livistona australis	Cabbage Tree Palm	20 x 6	Min 6m trunk	As Shown
	FERNS				
Aa	Asplenium australasicum	Bird's Nest Fern	1.3 x 0.8	45LT	As Shown
Bc	, Blechnum Cartilagineum	Gristle Fern	1 x 1	45LT	As Shown
Ca	Cyathea australis	Rough Tree Fern	6 x 5	Min 2m trunk	As Shown
Da	Dicksonia antarctica	Soft Tree Fern	8 x 4	Min 2m trunk	As Shown
Pb	Platycerium bifurcatum	Elkhorn Fern	2 x 2	45LT	As Shown
Tb	Todea barbara	King Fern	1 x 2	45LT	As Shown
	UNDERSTOREY PLANTS				
Aam	Adiantum aethiopicum	Maidenhair Fern	0.2 x 0.3	140mm	8/sqm
Cc	Commelina cyanea	Scurvy Weed	0.2 x 0.3	140mm	8/sqm
CGJ	Callistemon 'Green John'	Green John	1 x 1	25L	As Shown
Dc	Dianella caerulea	Flax Lily	0.6 x 0.6	140mm	8/sqm
Di	Dianella revoluta	Blue Flax Lily	0.6 x 0.6	140mm	8/sqm
Do	Doodia aspera	Rasp Fern	0.5 x 0.5	140mm	8/sqm
Dr	Dichondra repens	Kidney Weed	0.3 x 5	140mm	8/sqm
Hs	Hibbertia scandens	Guinea Flower	0.5 x 3	140mm	8/sqm
LT	Lomandra longifolia 'Tanika'	Tanika	0.5 x 0.6	140mm	8/sqm
Vhe	Viola hederacea	Ivy Leaf Violet	0.1 x 1	140mm	8/sqm

SHRUBS & ACCENTS						
Ah	Actinotus helianthi	Flannel Flower	0.5 x 0.5	140mm	8/sqm	
CAR	Carpobrotus 'Aussie Rambler'	Aussie Rambler	0.25 x 0.5	140mm	8/sqm	
CGW	Casuarina glauca 'Shagpile'	Shagpile	0.25 x 1.5	140mm	8/sqm	
Da	Dichondra argentea	Silver Falls	0.2 x 2	140mm	8/sqm	
Dc	Dianella caerulea	Flax Lily	0.6 x 0.6	140mm	8/sqm	
Ee	Echeveria elegans	Hens and Chickens	0.2 x 0.3	140mm	8/sqm	
GRR	Grevillea 'Royal Rambler'	Royal Rambler	0.2 x 0.5	140mm	8/sqm	
MY	Myoporum parvifolium 'Yareena'	Creeping Boobialla	0.3 x 3	140mm	8/sqm	
WGB	Westringia fruticosa 'Grey Box'	Grey Box Coastal Rosemary	0.5 x 0.5	140mm	8/sqm	
WLH	Westringia fruticosa 'Low Horizon'	Low Horizon	0.5 x 1	140mm	8/sqm	



96-98 Ben Boyd Road Neutral Bay Landscape Concept

#### LAND & ENVIRONMENT COURT NSW APPROVED

# LANDSCAPE PLAN | GROUND







## 96-98 BEN BOYD ROAD, NEUTRAL BAY **DEVELOPMENT APPLICATION**



CLIENT


# ARCHITECT

**PREPARED BY** Arcadia Landscape Architecture Aidop No.3 Pty Ltd MHNDU

DATE	28.10.2022
SCALE	1:100@A1
ISSUE	D

Copyright remains the property of Arcadia Landscape Architecture Pty Ltd. Use only figured dimensions. Any other required dimensions are to be referred to and supplied by the landscape architect. All discrepancies to be referred to the project manager and Arcadia Landscape Architecture Pty Ltd prior to construction. Ensure compliance with the Building Code of Australia and all relevant Australian Standards and Authorities

# LANDSCAPE PLAN | ROOFTOPS

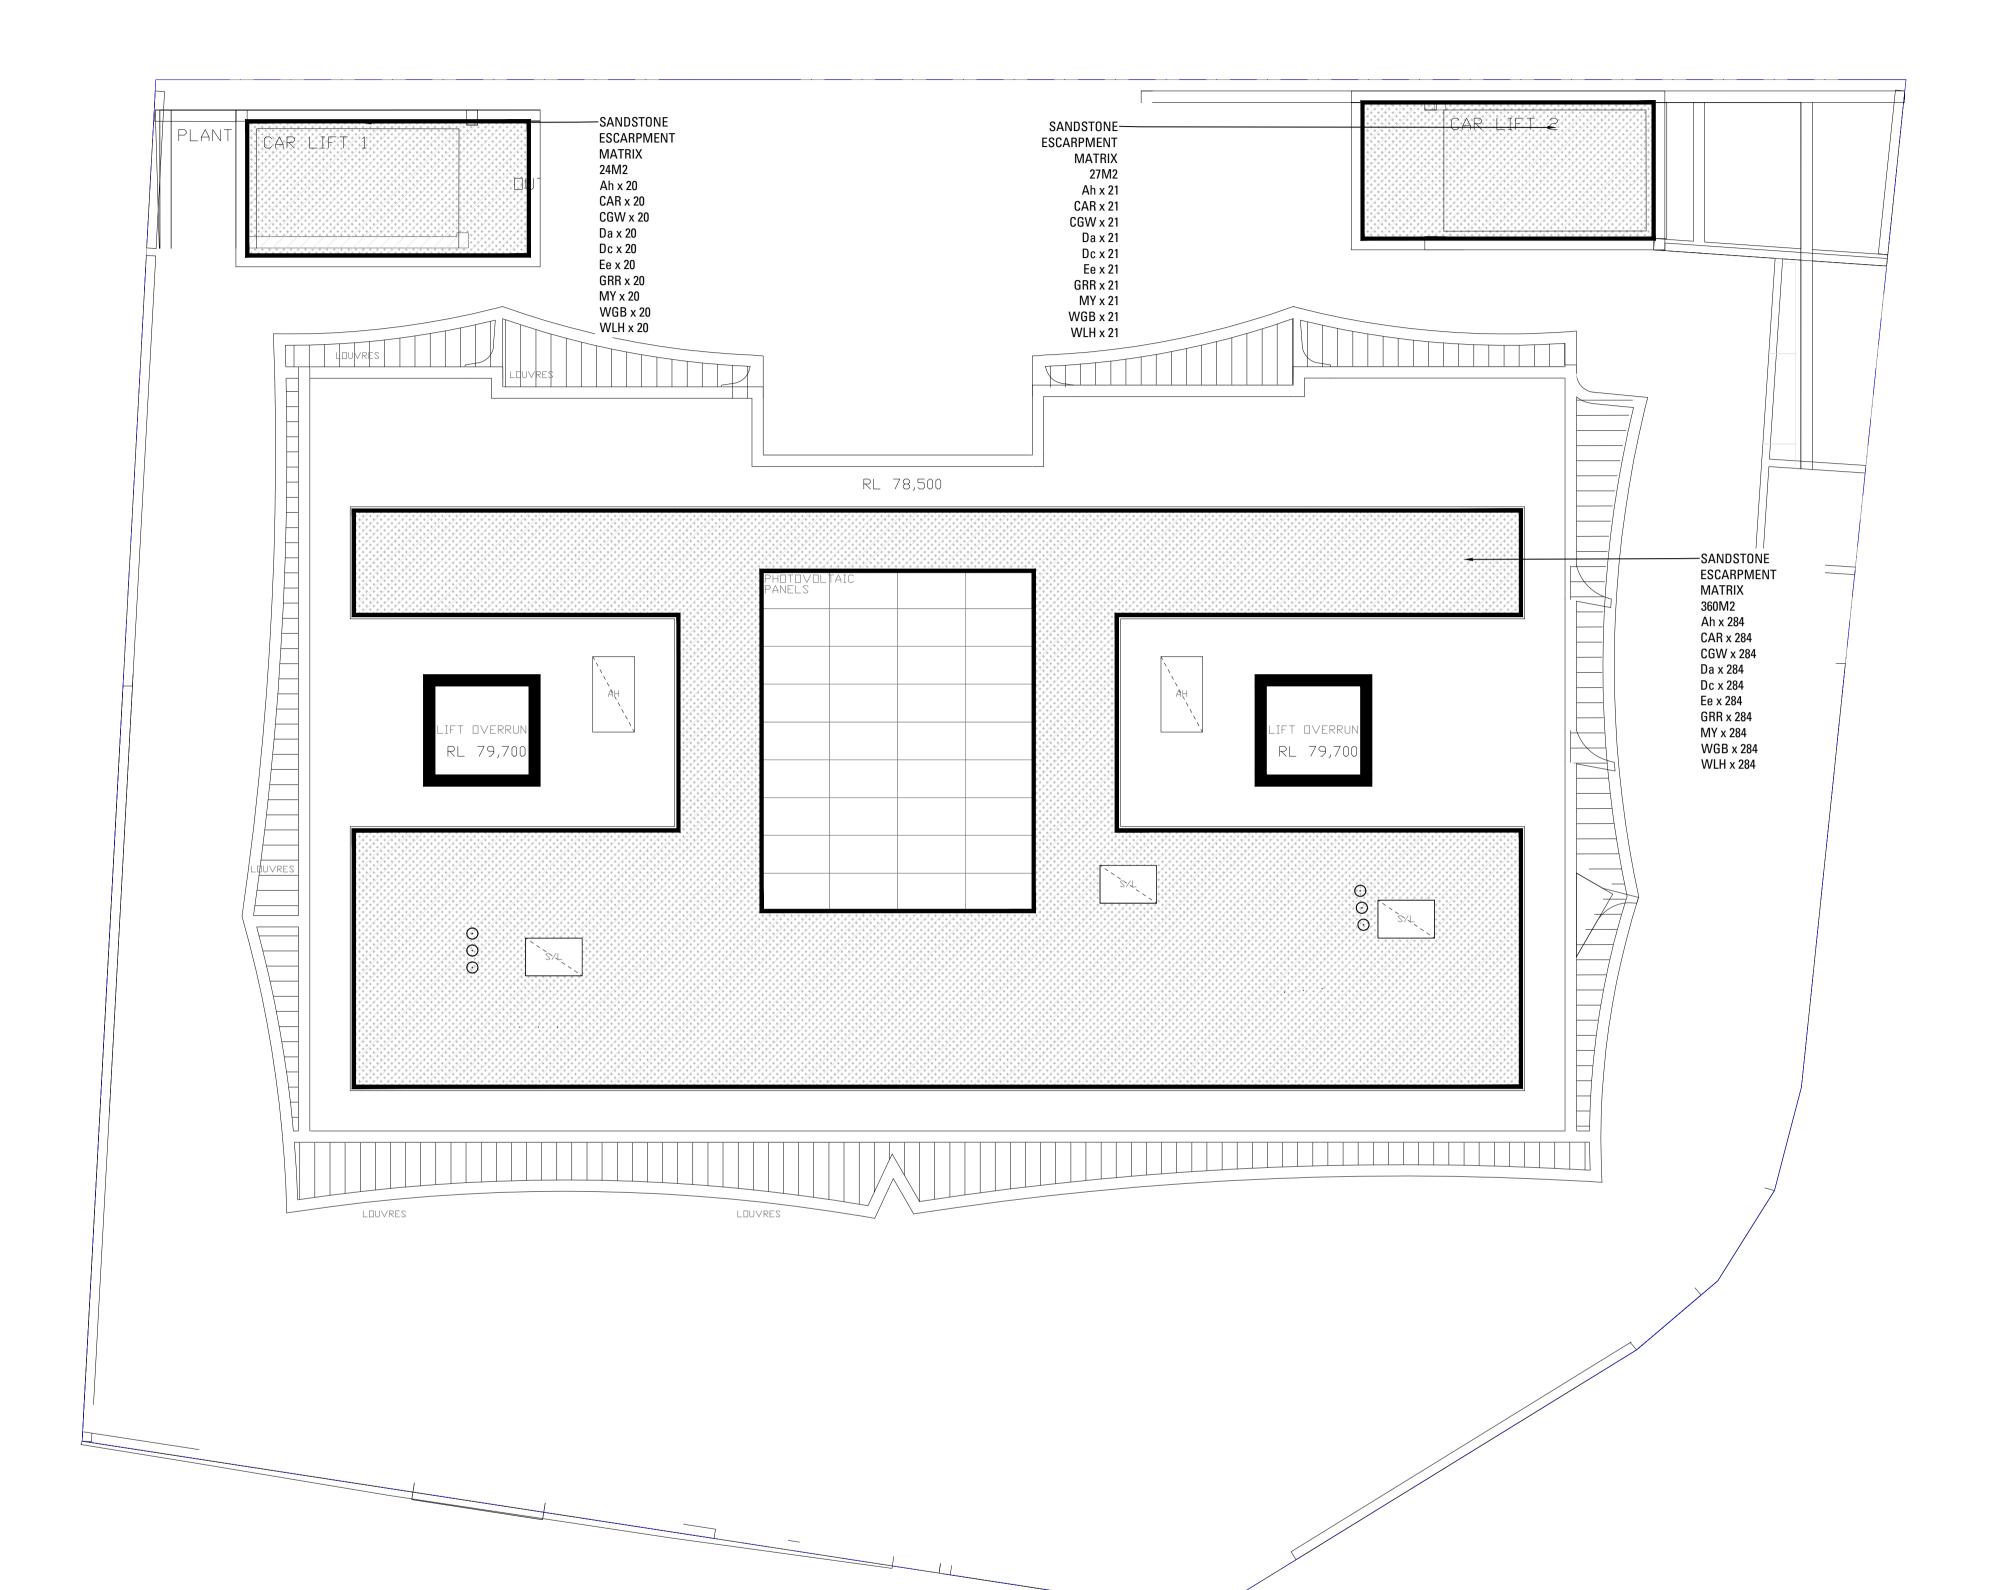





## LAND & ENVIRONMENT COURT NSW APPROVED

## 96-98 BEN BOYD ROAD, NEUTRAL BAY **DEVELOPMENT APPLICATION**




**PREPARED BY** Arcadia Landscape Architecture Aidop No.3 Pty Ltd MHNDU CLIENT ARCHITECT

Copyright remains the property of Arcadia Landscape Architecture Pty Ltd. Use only figured dimensions. Any other required dimensions are to be referred to and supplied by the landscape architect. All discrepancies to be referred to the project manager and Arcadia Landscape Architecture Pty Ltd prior to construction. Ensure compliance with the Building Code of Australia and all relevant Australian Standards and Authorities






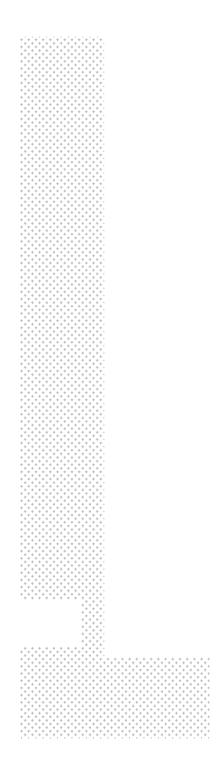



28.10.2022 SCALE 1:100 @ A1


# LANDSCAPE DETAILS

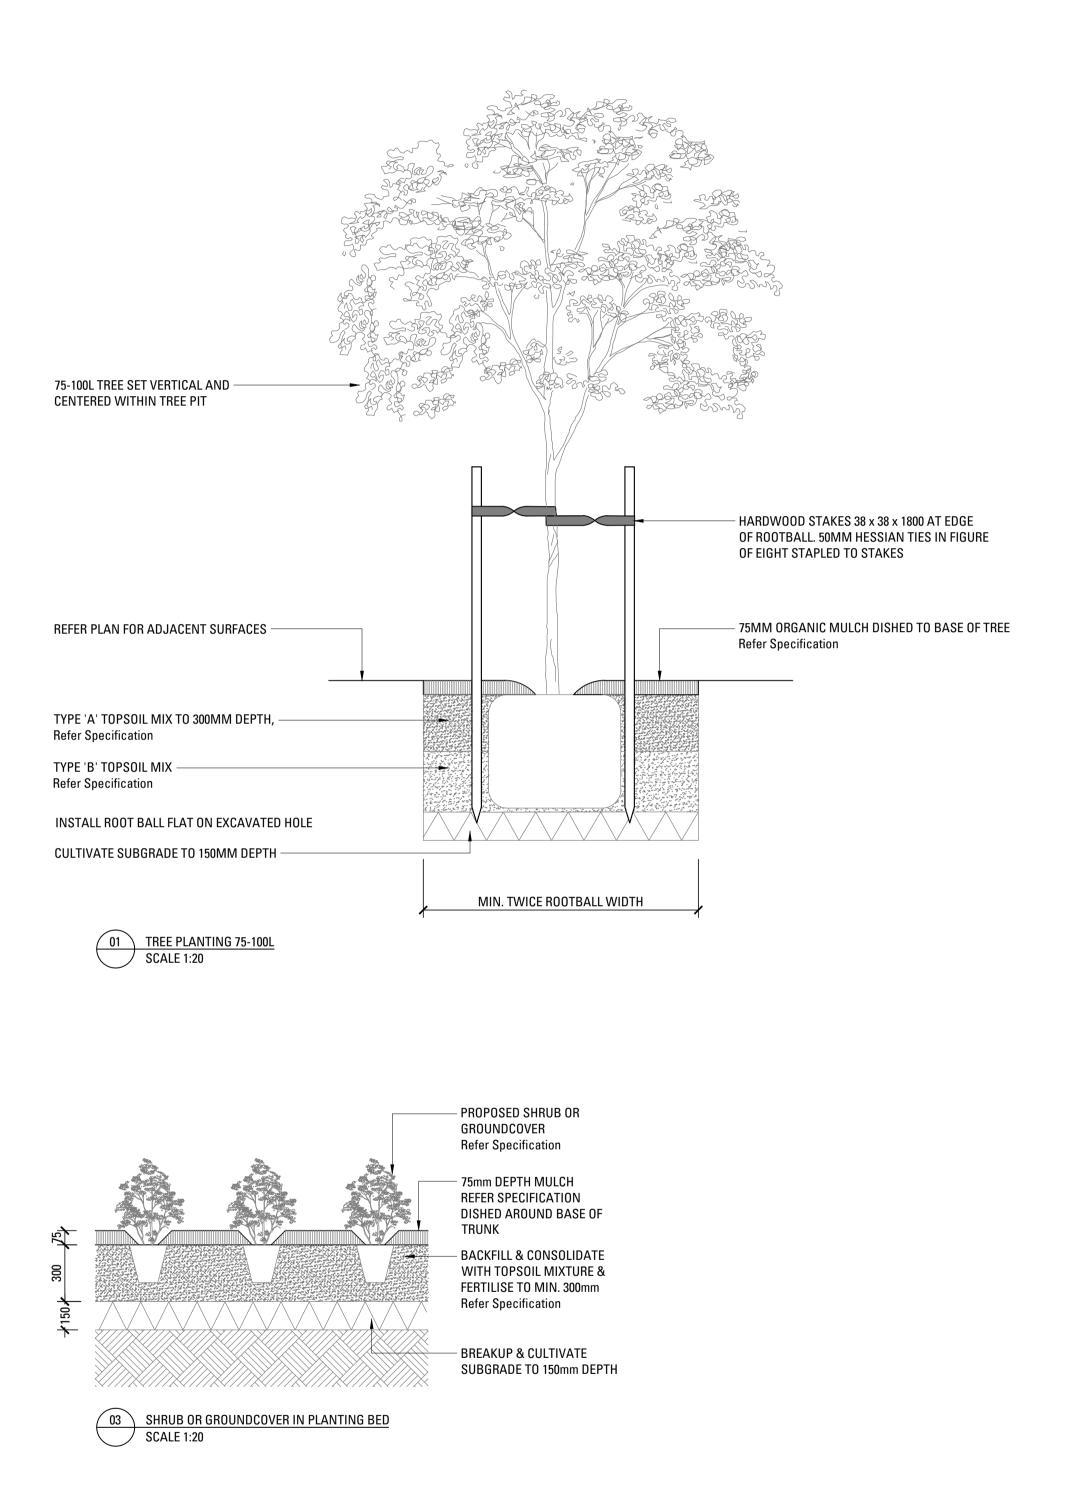





### ATTACHMENT TO LPP04 - 03/04/24

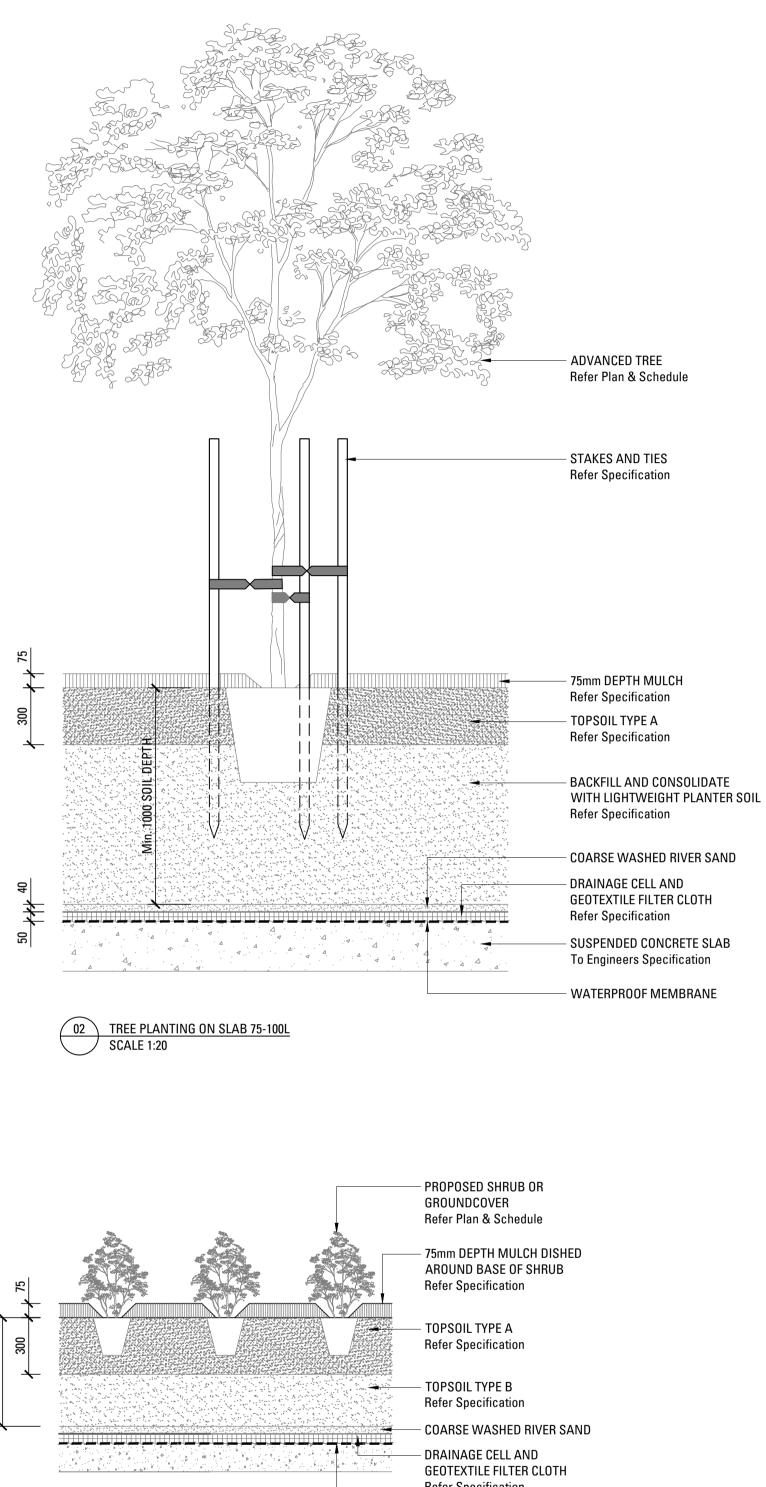

04 PLANTING ON SLAB SCALE 1:20

Refer Specification

- WATERPROOF MEMBRANE



# 96-98 BEN BOYD ROAD, NEUTRAL BAY **DEVELOPMENT APPLICATION**

LAND & ENVIRONMENT COURT NSW APPROVED





**Refer Specification** 

Jun All July ( July )

PROPOSED TURF



BREAK UP & CULTIVATE SUBGRADE TO 150mm DEPTH



Colubert March 1000 March 1000

ARCHITECT

**PREPARED BY** Arcadia Landscape Architecture Aidop No.3 Pty Ltd MHNDU



28.10.2022 As Shown @ Al

Copyright remains the property of Arcadia Landscape Architecture Pty Ltd. Use only figured dimensions. Any other required dimensions are to be referred to and supplied by the landscape architect. All discrepancies to be referred to the project manager and Arcadia Landscape Architecture Pty Ltd prior to construction. Ensure compliance with the Building Code of Australia and all relevant Australian Standards and Authorities



200 Miller Street, North Sydney, NSW 2060 ABN 32 353 260 317 All correspondence PO Box 12, North Sydney, NSW 2059 P (02) 9936 8100 E council@northsydney.nsw.gov.au W www.northsydney.nsw.gov.au

Aidop No 3 Pty Ltd Suite 5.06, Level 5, 55 Miller Street PYRMONT NSW 2009

NORTH SYDNEY

COUNCIL

D86/22 TH2 (CIS)

facebook.com/NthSydCouncil twitter.com/NthSydCouncil

onorth.sydney

#### ENVIRONMENTAL PLANNING AND ASSESSMENT ACT, 1979 AS AMENDED SECTION 4.56 APPLICATION 86/22/2 - APPROVAL

Development Consent Number:	DA 86/22/2
Land to which this applies:	96-98 Ben Boyd Road, Neutral Bay Lot No.: A, DP: 348364
Applicant:	Aidop No 3 Pty Ltd
Proposal:	Section 4.56 modification relating to development consent DA 86/2022 for consolidation of 2 lots, demolition of existing structures, excavation and construction of a six- storey residential flat building containing 21 apartments over two levels of basement parking and parking at grade, landscaping and associated works at 96-98 Ben Boyd Road, Neutral Bay.

The 4.56 application was considered by the **North Sydney Local Planning Panel (NSLPP)** on 4 October 2023.

Pursuant to Section 4.56 of *the Act* notice is hereby given of the determination by the consent authority of your request for a modification to Development Consent No. **86/22** and registered in Council's records as Application No. **86/22/2** relating to the land described as **96-98 Ben Boyd Road, Neutral Bay**.

Your request for the modification of the Development Consent as set out in Notice of Determination dated 30 November 2022, has been determined in the following manner: -

#### A. Impose Condition A7, C50, C51 and C52 as follows:

#### **Development in accordance with Plans (s4.56 Amendments)**

**A7.** The development being carried out in accordance with plans identified in Condition A1 of the consent endorsed with Council's approval stamp, except as modified by the modifications shown on:

## RE: 96-98 BEN BOYD ROAD, NEUTRAL BAY DEVELOPMENT CONSENT NO. 86/22/02

Page **2** of **8** 

Plan No.	Rev	Title	Drawn by	Received
DA 0000	F	Cover Page	MHNDUNION	12/09/2023
DA 0001	F	Project Summary	MHNDUNION	12/09/2023
DA 1000	F	Site Context	MHNDUNION	12/09/2023
DA 1001	F	Site Analysis	MHNDUNION	12/09/2023
DA 1002	F	Site Plan	MHNDUNION	12/09/2023
DA 1003	F	Demolition Plan	MHNDUNION	12/09/2023
DA 2000	F	Basement 02 Plan	MHNDUNION	12/09/2023
DA 2001	F	Basement 01 Plan	MHNDUNION	12/09/2023
DA 2002	F	Ground Floor Plan	MHNDUNION	12/09/2023
DA 2003	F	Level 1 Floor Plan	MHNDUNION	12/09/2023
DA 2004	F	Level 2 Floor Plan	MHNDUNION	12/09/2023
DA 2005	F	Level 3 Floor Plan	MHNDUNION	12/09/2023
DA 2006	F	Level 4 Floor Plan	MHNDUNION	12/09/2023
DA 2007	F	Level 5 Floor Plan	MHNDUNION	12/09/2023
DA 2008	F	Roof Plan	MHNDUNION	12/09/2023
DA 3000	F	North Elevation	MHNDUNION	12/09/2023
DA 3001	F	South Elevation	MHNDUNION	12/09/2023
DA 3002	F	East Elevation	MHNDUNION	12/09/2023
DA 3003	F	West Elevation	MHNDUNION	12/09/2023
DA 3100	F	Section A	MHNDUNION	12/09/2023
DA 3101	F	Section B	MHNDUNION	12/09/2023
DA 6000	F	External Finishes 01	MHNDUNION	12/09/2023
DA 6001	F	External Finishes 02	MHNDUNION	12/09/2023
DA 9100	F	SEPP 65 – Solar & Cross	MHNDUNION	12/09/2023
27.0200		Ventilation		,,
DA 9101	F	SEPP 65 - Storage	MHNDUNION	12/09/2023
DA 9102	F	Landscape Calculation	MHNDUNION	12/09/2023
DA 9103	F	Site Coverage Diagram	MHNDUNION	12/09/2023
DA 9104	F	Height Plane Diagram	MHNDUNION	12/09/2023
DA 9300	F	Waste Management Plan	MHNDUNION	12/09/2023
DA 9301	F	Adaptable Unit Layout	MHNDUNION	12/09/2023
Landscape	plans	· · · · · · · · · · · · · · · · · · ·		<u>.</u>
Page 21	G	Concepts Landscape Plan	Arcadia Landscape Architecture	13/04/2023
Page 22	G	Concepts Entry Forecourt	Arcadia Landscape Architecture	13/04/2023
Page 23	G	Concepts Entry Forecourt	Arcadia Landscape Architecture	13/04/2023
Page 24	G	Concepts Private Courtyard	Arcadia Landscape Architecture	13/04/2023
Page 25	G	Concepts Private	Arcadia Landscape	13/04/2023
Fage 25	0	Courtyard	Architecture	13/04/2023
Page 26	G	Concepts Sandstone Edge	Arcadia Landscape	13/04/2023
T dgC 20	U	Conditions	Architecture	13/04/2023
Page 27	G	Concepts Rooftop Planting	Arcadia Landscape Architecture	13/04/2023
Page 28	G	Landscape Areas	Arcadia Landscape Architecture	13/04/2023
Page 29	G	Canopy Cover	Arcadia Landscape Architecture	13/04/2023
Page 30	G	Design Strategies Material Look and Feel	Arcadia Landscape Architecture	13/04/2023

## RE: 96-98 BEN BOYD ROAD, NEUTRAL BAY DEVELOPMENT CONSENT NO. 86/22/02

Dago 21	G	Decign Strategies	Arcadia Landscano	13/04/2023
Page 31	G	Design Strategies	Arcadia Landscape	15/04/2025
		Indicative Lighting Strategy	Architecture	
Page 32	G	Design Strategies Planting	Arcadia Landscape	13/04/2023
		Look and Feel	Architecture	
Page 33	G	Design Strategies Planting	Arcadia Landscape	13/04/2023
		Palette	Architecture	
Page 34	G	Design Strategies Planting	Arcadia Landscape	13/04/2023
		Schedule	Architecture	
SK1	G	Landscape Plan Ground	Arcadia Landscape	13/04/2023
			Architecture	
SK2	G	Landscape Plan Rooftops	Arcadia Landscape	13/04/2023
			Architecture	
SK3	G	Landscape Details	Arcadia Landscape	13/04/2023
			Architecture	

<sup>(</sup>Reason: To ensure that the form of the development undertaken is in accordance with the determination of Council, Public Infrastructure)

#### **Ground Level Parking Design Change**

**C50.** The communal room is to be enlarged to the west by approximately 1.2m, the DDA car parking space is to be relocated to the west to accommodate for the enlarged communal room and the car parking space adjacent to the visitor car parking for use as a storage cage will be redesigned as both a space for motorbike parking and storage cage.

The Ground Floor Plan must be submitted to Council for the written approval of Council's Assessment Team Leader prior to the issue of any construction certificate.

(Reason: To ensure appropriate provision of internal common space and appropriate provision of parking and storage)

#### **Balconies – Design Amendments**

**C51.** The southern balcony that serves Units 102 & 103 on Level 1, Units 202 & 203 on Level 2, Units 302 & 303 on Level 3, Unit 402 on Level 4 and Unit 502 on Level 5 is to be amended so not to be a continuous balcony but encompass a break in form as per that approved under DA 86/22 – LEC No. 2022/165233. The balconies subject to design amendments are clouded in red on the approved plans in A7 of this modification application consent.

The Level 5 balcony on the western side of the building (Unit 501) is not approved and shall remain as per the balcony approved under determination for DA 86/22 – LEC No. 2022/165233. The respective balcony subject to design amendments is clouded in red on Level 5 Floor Plan, DA 2007 Rev F.

The floor plans (Levels 1-5) and elevations must be submitted to Council for the written approval of Council's Manager Development Services prior to the issue of any construction certificate.

(Reason: To ensure control in site density, maintenance in articulation in built form to the streetscape and minimise additional exceedance in site coverage)

#### Deep Soil Area

**C52.** The rectangular deep soil area to the northern boundary of the site shall remain unexcavated or be reinstated with no continuous slab at the base as per that in Section B, DA 3101 Rev approved under DA 86/22 – LEC No. 2022/165233.

An amended Section must be submitted to Council for the written approval of Council's Manager Development Services prior to the issue of any construction certificate.

(Reason: To minimise excavation and site disturbance and to enhance natural drainage)

#### B. Modify Conditions A5, C13, C31, C44, C49 and G21 as follows:

#### Works to Stone Wall

**A5.** All works to the stone wall at the Ben Boyd boundary of the site are to follow the methodology provided in the Stone Wall Reconstruction Methodology, John Outram Heritage Design, dated 21 November 2022. The works are to be guided by a suitably qualified heritage consultant and undertaken by a stonemason experienced in heritage work. Any variation to the works methodology will be notified in writing to the manager of development services and will require sign off by the manager of development services within Council.

FBHV Cabinet - The proposed new fire services cabinet to be located within the sandstone wall is to be painted in a visually submissive colour that is sympathetic to the sandstone wall.

(Reason: To ensure the appropriate conservation of the stone wall)

#### **Bicycle Storage and Parking**

**C13.** The bicycle storage area must accommodate a minimum of 21 20 bicycles, and a visitor parking bicycle rail shall be provided for 3 2 visitor bicycles. The bicycle storage lockers and bicycle rail shall be designed in accordance with the applicable Australian Standards. Plans and specifications which comply with this condition must be submitted to the Certifying Authority for approval prior to the issue of the relevant Construction Certificate. The Certifying Authority must ensure that the building plans and specifications, referenced on and accompanying the issued Construction Certificate, fully satisfy the requirements of this condition.

(Reason: To promote and provide facilities for alternative forms of transport)

#### Location of Plant

- **C31.** Except where shown on the approved plans identified in condition A7, All-plant and equipment (including but not limited to air conditioning equipment) is to be located within the basement of the building or adjoining the car park lift shaft and is not to be located on balconies or the roof. Fireplace flues to roof areas are permitted (in accordance with Condition C10). Plans and specifications complying with this condition must be submitted to the Certifying Authority for Approval prior to the issue of the relevant Construction Certificate. The Certifying Authority must ensure that the building plans and specifications submitted, referenced on and accompanying the issued Construction Certificate, fully satisfy the requirements of this condition.
  - (Reason: Minimise impact on surrounding properties, improved visual appearance and amenity for locality)

#### **BASIX Certificate**

- **C44.** Under clause **75** of the *Environmental Planning and Assessment Regulation 2021*, it is a condition of this development consent that all the commitments listed in BASIX Certificate No. <u>1273153M\_03</u>, dated <u>21</u> November <u>2022</u> **1273153M\_04** dated <u>4</u> April <u>2023</u>, for the development are fulfilled. Plans and specifications complying with this condition must be submitted to the Certifying Authority for approval prior to the issue of the relevant Construction Certificate. The Certifying Authority must ensure that the building plans and specifications submitted, referenced on and accompanying the issued Construction Certificate, fully satisfy the requirements of this condition.
  - (Reason: To ensure the proposed development will meet the Government's requirements for sustainability and statutory requirements)

#### Pedestrian Sight Distance at Vehicular Exit Driveway

- **C49.** A pedestrian sight triangle of 2.0 metres by 2.5 metres is to be provided on both sides of the vehicular egress driveway in accordance with AS2890.1:2004. Any variation to this sight distance requirement would need to be assessed by an appropriately qualified traffic engineer and supplemented with additional traffic control devices such as convex mirrors at the egress (within the site) to assist with sight lines, with the variation to not result in any detrimental impact in terms of pedestrian safety. Details demonstrating compliance with the requirements of this condition are to be submitted to the Certifying Authority prior to the issue of a Construction Certificate.
  - (Reason: To ensure pedestrian safety at the site exit driveway)

#### Allocation of Spaces

**G21.** Car parking spaces must be provided and maintained at all times on the subject site. The spaces shall be allocated to uses within the building in accordance the following table:

Residential	Parking
	Spaces
Residential (including 4 accessible spaces)	27
Visitor (excluding carwash bay)	3
Total	30 spaces

The car parking spaces are to be identified on-site by line-marking and numbering upon the completion of the works and prior to issue of Occupation Certificate. Car parking spaces provided must only be used in conjunction with the approved uses contained within the development.

In the case of Strata subdivision any car parking for strata lots for residential purposes must be individually allocated to its corresponding residential strata lot as part of each lots' unit entitlement.

Visitor parking facilities must be designated as common property on the strata plan. Visitor parking facilities must not at any time be allocated, sold, licensed or leased for the exclusive use of any occupier or owner and must be retained as common property by the Owners Corporation for use by building visitors.

(Reason: To ensure that adequate parking facilities to service the development are provided on site)

Reasons for approval:	The Panel is of the view that excavation is to be minimised and deep soil optimised. The Panel also considers that the engineered deep soil areas are to be free of any continuous constructed slab. The Panel is of the view that the street elevation would benefit from additional articulation to the balconies similar to the original approval. The Panel agrees that the louvres can be replaced with concrete to allow floor to ceiling doors on the eastern elevation.
How community views were taken into account:	The application has been notified in accordance with Council's Community Consultation Plan with adjoining properties and the Neutral Bay Precinct notified between 12 May to 26 May 2023. In response to the notification Council received no submissions to the proposal.

The conditions attached to the original consent for Development Application No. 86/22 by endorsed date of 30 November 2022 still apply.

#### ADVISINGS

(a) Council is always prepared to discuss its decisions and in this regard, please do not hesitate to contact **Thomas Holman**. However, if you wish to pursue your rights of appeal in the Land and Environmental Court pursuant to Section 8.7 of the *Environmental Planning and Assessment Act 1979* (as amended), you are advised that Council generally seeks resolution of such appeals through a Section 34 Conference, instead of a full Court hearing, subject to any further advice to the contrary from Council's Solicitors and senior staff. Such an approach is less adversarial, it achieves a quicker decision than would be the case through a Court hearing and it can give rise to considerable cost and time savings for all parties involved.

- (b) Pursuant to Section 8.2, an applicant is able to request Council to review its determination. An application for a review under Section 8.2 of *the Act* must be made no later than 28 days after the date on which the application for the modification of the development consent was determined.
- (c) Prior to commencing any building, subdivision or associated constructions works, the following provisions of the *Environmental Planning and Assessment Act 1979* (*the 'Act'*) are to be complied with:
  - (i) A Construction Certificate is to be obtained in accordance with Section 6.3 of the Act.
  - (ii) A Principal Certifier is to be appointed and Council is to be notified of the appointment in accordance with Section 6.6 of *the Act*.
  - (iii) Council is to be notified at least two (2) days of the intention to commence building works, in accordance with Section 6.6(2)(a) of *the Act*.
- (d) You are advised that changes to the external configuration of the building, changes to the site layout, density and unit configuration internal changes to the proposed building or any changes to the proposed operation of a use MAY require the submission of a further modification under Section 4.55 of the *Environmental Planning & Assessment Act, 1979* (as amended).

Council staff would be pleased to assist in identifying such changes which may require the submission of a modification of a Development Application under Section 4.55 of the *Environmental Planning & Assessment Act*.

#### Endorsed for and on behalf of North Sydney Council

13 October 2023

 $\sim$ 

DATE

Signature on behalf of consent authority ISOBELLA LUCIC TEAM LEADER (ASSESSMENTS)



200 Miller Street, North Sydney, NSW 2060 ABN 32 353 260 317 All correspondence PO Box 12, North Sydney, NSW 2059 P (02) 9936 8100 E council@northsydney.nsw.gov.au W www.northsydney.nsw.gov.au

21 November 2023

Page 76

Aidop No 3 Pty Ltd Suite 5.06, Level 5, 55 Miller Street **PYRMONT NSW 2009** 

NORTH SYDNEY

COUNCIL

D86/22/2 TH2 (CIS)

Dear Sir/Madam

RE:

#### **CONDITION C50 – GROUND LEVEL PARKING DESIGN CHANGE CONDITION C51 – BALCONIES DESIGN AMENDMENTS CONDITION C52 – DEEP SOIL AREA** DA 86/22/02 **APPLICATION NO: PROPERTY:** 96-98 BEN BOYD ROAD, NEUTRAL BAY

I refer to the abovementioned modification application approved by the North Sydney Local Planning Panel (NSLPP) on 04 October 2023 and the amended plans submitted on 01 November 2023 seeking to satisfy the requirements of Condition C50 (Ground Level Parking Design Change), Condition C51 (Balconies Design Amendments) and Condition C52 (Deep Soil Area).

The amended plans (Drawing No. 2002 – Ground Floor Plan, Rev G and Drawing No. 3101 – Section B, Rev G dated June 2023) received by Council on 01 November 2023 have been reviewed by Council Officers and are considered to generally satisfy the following requirements of Conditions C50 & C52.

#### **Ground Level Parking Design Change**

The communal room is to be enlarged to the west by approximately 1.2m, the DDA car C50. parking space is to be relocated to the west to accommodate for the enlarged communal room and the car parking space adjacent to the visitor car parking for use as a storage cage will be redesigned as both a space for motorbike parking and storage cage.

The Ground Floor Plan must be submitted to Council for the written approval of Councils Assessment Team Leader prior to the issue of any construction certificate.

(Reason: To ensure appropriate provision of internal common space and appropriate provision of parking and storage)

#### **Deep Soil Area**

The rectangular deep soil area to the northern boundary of the site shall remain C52. unexcavated or be reinstated with no continuous slab at the base as per that in Section B, DA 3101 Rev approved under DA 86/22 – LEC No. 2022/165233.

An amended Section must be submitted to Council for the written approval of

2

Council's Manager Development Services prior to the issue of any construction certificate.

(Reason: To minimise excavation and site disturbance and to enhance natural drainage)

A copy of this correspondence, in addition to copies of all documents relating to the above conditions must be provided to the Certifying Authority for their approval prior to the issue of any Occupation Certificate.

However, Condition C51 Balconies – Design Amendments is <u>not</u> satisfied and amended plans have not been submitted which comply with the wording or design intent of the condition. Condition C51 as required by the Planning Panel states:

#### **Balconies – Design Amendments**

**C51.** The southern balcony that serves Units 102 & 103 on Level 1, Units 202 & 203 on Level 2, Units 302 & 303 on Level 3, Unit 402 on Level 4 and Unit 502 on Level 5 is **to be amended so not to be a continuous balcony but encompass a break in form as per that approved under DA 86/22 – LEC No. 2022/165233.** The balconies subject to design amendments are clouded in red on the approved plans in A7 of this modification application consent.

The Level 5 balcony on the western side of the building (Unit 501) is not approved and shall remain as per the balcony approved under determination for DA 86/22 – LEC No. 2022/165233. The respective balcony subject to design amendments is clouded in red on Level 5 Floor Plan, DA 2007 Rev F.

The floor plans (Levels 1-5) and elevations must be submitted to Council for the written approval of Council's Manager Development Services prior to the issue of any construction certificate.

(Reason: To ensure control in site density, maintenance in articulation in built form to the streetscape and minimise additional exceedance in site coverage)

The amended plans provided do not satisfy the design requirements of the condition and do not reflect the plans approved by the NSW Land & Environment Court. Furthermore, additional changes to the southern balconies to Units 101, 104, 201, 204, 301, 304, 401, 403, 501 & 503 are proposed not required by Condition C51. Noting the advice provided to you, it is recommended that you provide the amendments required by this condition or seek a Modification of the consent under S.4.56 of the EP & A Act 1979.

Should you wish to discuss this information, please do not hesitate to contact Council's Assessment Officer, Thomas Holman, during business hours on **9936 8357**.

STEPHEN BEATTIE MANAGER DEVELOPMENT SERVICES

 $\sim$  1

1

γ

#### 96-98 BEN BOYD RD, **NEUTRAL BAY NSW 2089**

DECEMBER, 2023


1.

#### REV H: DESIGN AMENDMENTS TO ADDRESS CONDITIONS C51 SET OUT IN S 4.56 86/22/2

- 2.

DWG NO.	DRAWING NAME	REVISION
DA 0000	COVERPAGE	Н
DA 2002	GROUND FLOOR PLAN	Н
DA 2003	LEVEL 1 FLOOR PLAN	Н
DA 2004	LEVEL 2 FLOOR PLAN	Н
DA 2005	LEVEL 3 FLOOR PLAN	Н
DA 2006	LEVEL 4 FLOOR PLAN	Н
DA 2007	LEVEL 5 FLOOR PLAN	Н
DA 3001	ELEVATION SOUTH	Н

REV	DESCRIPTION	DATE	ALL CONSTRUCTION TO COMPLY AT MINIMUM WI BCA CLAUSES & AUSTRALIAN STANDARDS		ARTIFICIAL LIGHTING: TO COMPLY WITH BCA PART CLAUSEF4.4 & AS1680 BALUSTRADE HEIGHTS: TO COMPLY WITH BCA CLAUSE D2.16	BASIX COMMITMENTS (ALL OTHER BASIX COMMITM	IENTS AS PER BASIX CERTIFICATE AND STAMPED			NOTES:	ARCHITECT:	DRAV
н	S.456_ BALCONY AMENDMENTS	14/12/2023	CLAUSE B 1.4 MATERIAL & FORMS CONSTRUCTIONS SPEC. C1.1 FIRE RESISTING CONSTRUCTION SPEC. C1.10 FIRE HAZARD PROPERTIES SPEC. C1.19 FIRE PROFUNANCE OF EXTERNAL WALLS IN A FIRE	CLAUSE D2.17 HANDRAILS CLAUSE D2.21 OPERATION OF LATCH CLAUSE D2.23 SIGNS ON DOORS CLAUSE D2.20 SERVERA BUILDING ACCESS REQUIREMENTS	DRAINAGE GUTTERS & DOWNPIPES: TO COMPLY WITH ASNCS 3500 3.2 ENERGY EFFICIENCYGLAZING: TO COMPLY WITH 32 OF BCA FIRE SERVICES: TO COMPLY WITH SECTIONE OF BCA HOT WATER: SYSTEMS TO COMPLY WITH PART J7 OF BCA MASONRY: TO COMPLY WITH SATO	PLANS) WATER OPTIONS SHOMEHHEADS TOLETS KITCHEN TAPS: BATHROOM TAPS: STORMUTER/ RANUATER TA	4 53% (+ 7.51./min fice) 5 53% 6 53% 6 53% 8 65%	WATER HEATING ENERGY EFFICIENT LIGHTING. COOK TOPS: VERTICAL TRANSPORT SYSTEM ALTERNATIVE SYSTEM. THERMAL CONFORT OPTIONS R30 INSULATION TO:	Gas cookop, electric oven 28: Gaarless tracion lifa with VVF motor 12:With photosobaic system 5: Ecocard nor & balconies ito achieve total		MHNDUNON	
			CLAISE C28 VERTICAL SEPARATION OF OPENNOS IN EXTERNAL WALL CLAISE C23 VERHARTION OF COLUMENT CLAISE C23 SEPARATION OF COLUMENT CLAISE C23 ELECTRICITY SUPPLY SYSYEM CLAISE C23 ELECTRICITY SUPPLY SYSYEM CLAISE C31 SOPENING IN FIRE ISCLAIED EXITS CLAISE C315 OPENING TOR SERVICE INSTILLATIONS CLAISE C315 INSCHARGE FROM EXITS	CUISE D32 GENERAL BULLIMIN ALLESS REQUIREMENTS CLUSE D33 DENT OF ACCESSIBLE CLUSE D33 DENT OF ACCESSIBLE ALLESE D33 DENT OF ACCESSIBLE CLUSE P13 TWATERPROPENS OF VET AREAS CLUSE P13 TWATERPROPENS OF VET AREAS CLUSE P13 THATERPROPENS OF VET AREAS CLUSE P13 THATERPROPENS OF VET AREAS CLUSE P13 THATERPROPENS OF VET AREAS CLUSE P13 THAT O AMOR PROFENS CLUSE P13 THAT ALLESS OF VET AREAS CLUSE P13 THAT ALLESS OF VET ALLESS OF VET ALLESS OF VET ALLESS ALLESS OF VET ALLESS OF VET ALLESS OF VET ALLESS OF VET ALLESS OF VET ALLESS ALLESS OF VET ALLESS OF VET ALLESS OF VET ALLESS OF VET ALLESS OF VET ALLESS ALLESS OF VET ALLESS OF VET ALLESS OF VET ALLESS OF VET ALLESS OF VET ALLESS ALLESS OF VET ALLESS O	MECHELECHYDRAULC: CAC LAUSE C3 IS AS1530 4-005 MECHANICAL ARCONTIDIONIE'D COLMY WITH HART & GF BCA MECHANICAL EVHANUST VENTLATION: TO COMPLY WITH AS1668 & AS882 SIXIKE ALARMS: TO COMPLY WITH BCA PART CLAUSE & SPEC E2 2 & AS378 PAKETRATIONS: THROUGH FIRE RATED CONSTRUCTION FOR MECH	COLLECT RUN OF AREA LANDSCAPED AREA TO RINGA ENERGY OF COM COLLING & HEATING VENTLATION: - Apatomet - Basement Car Park		R20 INSULATION TO:	minimum R-solar al (D.2) Editoria dal subjective ta thirth minimum R- value of R2.8) Channisti et anapeninte concella solara bativesen conditioned and infernation - anolfoxied spaces thematively bates conditioned and rec.8. and to stress reconcertained analy B to alternative scale and and rec.8. and to stress reconcertained analy B to themation scale conditioned analytic scale scale B to the scale conditioned and the scale sca		35 RICHARDS LANE SURRY HILLS SYDNEY NSW 2010 T +61 2 9101 1111 F +61 2 9101 1100	96-98 NEUT APPLI
cumer	nt Set ID: 9868072		CLAUSE D27 INSTALLATIONS IN EXITS AND PATHS OF TRAVEL CLAUSE D213 GOINGS AND INSERS CLAUSE D214 LANDINGS CLAUSE D215 THRESHOLDS CLAUSE D216 BALUSTRADES	CLAUSE F5.4 SOLIND INSULATION OF FLOORS CLAUSE F5.5 SOUND INSULATION OF WALLS CLAUSE F5.5 SOUND INSULATION OF SERVICES CLAUSE F5.7 SOUND INSULATION OF PUMPS	ELECHYDRAULC PENETRATIONS TO COMPLY WITH BCA CLAUSE C3.15.4 ASIS30.4.000 SOUND TRANSMISSION: TO COMPLY WITH PARTS OF BCA STARE CONSTRUCTION: TO COMPLY WITH BCA CLAUSE D2.13 STARE CONSTRUCTION: TO COMPLY WITH BCA CLAUSE D2.13 WITEPPROOFING OF WIT AFASE. TO COMPLY WITH ASI240	- Conna, Fire Pump Room - Gerage - Strange, Colt Water, Hot Water - Main Switch Room - Unb and Fire staticture - Lobbies	Weltkino (schaat on) (with hereaktical) controlled Vertilation (schaat on) ( Vertilation (schaat on) ( Vertilation (schaat on)) (with time clock or BMS controlled Vertilation (schapt) on) (with time clock or BMS controlled	- Stylights - All other clarine	, Da = 51, SHC2 = 534 eg, Rumition Hand dubbe-glacing Ube = 73, SHC2 = 2.75 Ube = 513, SHC2 = 2.54 eg, Aluminum fræmed single glacing		WWW.mhndu.com Normated Advite Brin Meyter MHN Design Urion Pty Ltd. ABN 94.003.717.682 NSW Registration Number 49	

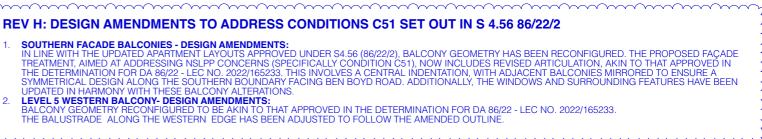

PLICATION **CTION 4.56** 


DRAWING TITLE: COVERPAGE PROJECT ADDRESS: 6-98 BEN BOYD RD, EUTRAL BAY NSW 2089 APPLICANT: AIDOP NO 3 PTY I TD SUITE 506, LEVEL 5, 55 MILLER ST, PYRMONT NSW 2009





REF: Nolumes/BMA Projects/21-095 Ben Boyd Rd Neutral Bay/V Post Panel Meeting/21-095 Ben Boyd Rd Neutral Bay - \$456 H t

#### ATTACHMENT TO LPP04 - 03/04/24

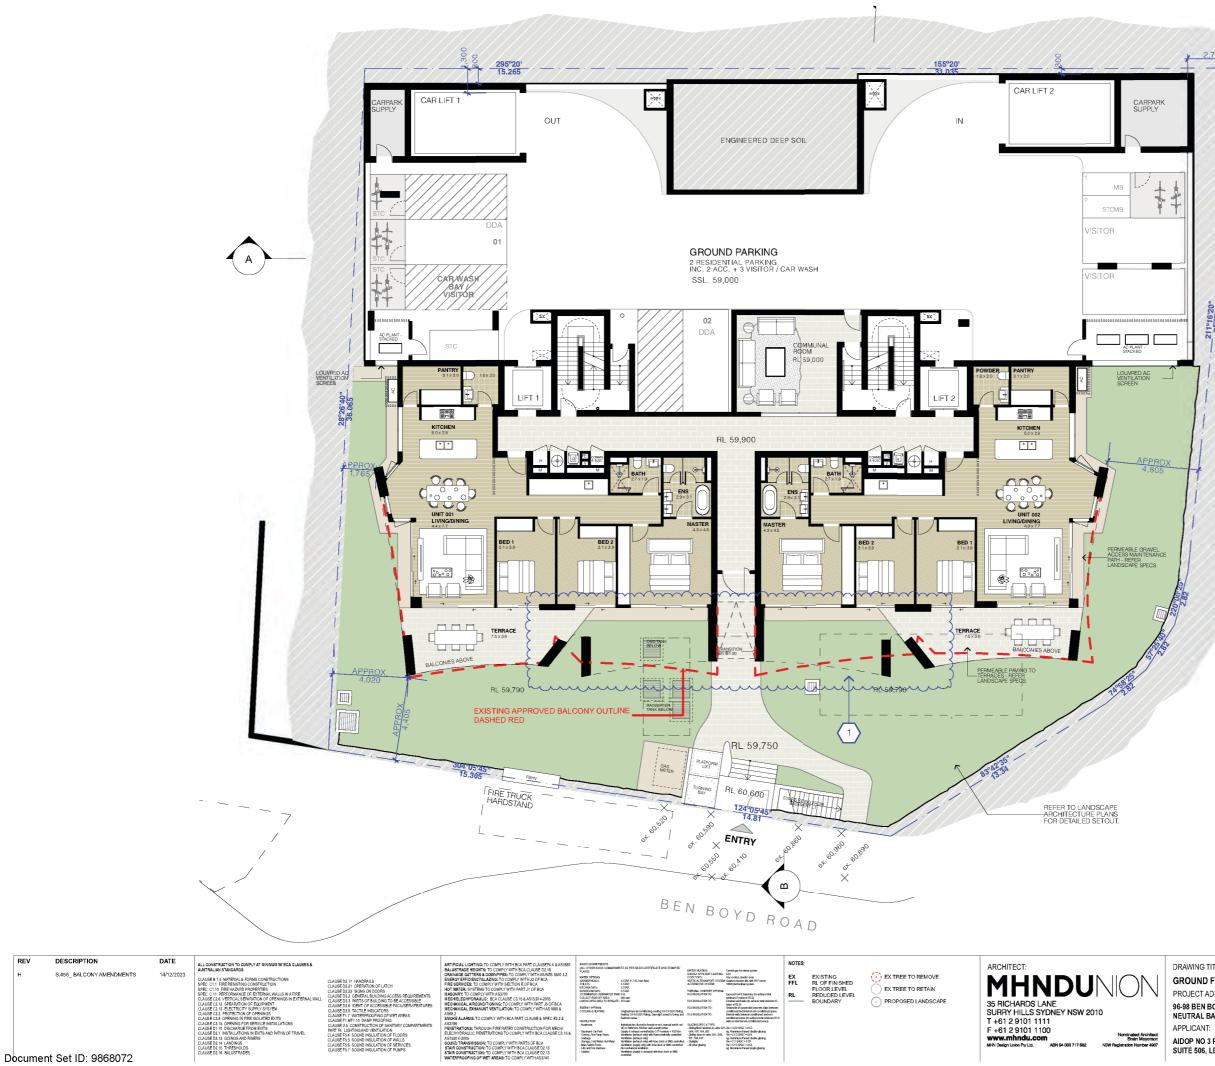

Version: 1, Version Date: 17/01/2024



S 4.56 86/22/2 SOUTHERN FACADE BALCONIES - DESIGN SOUTHERN FACADE BALCONIES - DESIGN AMENDMENTS: IN LINE WITH THE UPDATED APARTMENT LAYOUTS APPROVED UNDER S4.56 (86/22/2), BALCONY GEOMETRY HAS BEEN RECONFIGURED. THE PROPOSED FAÇADE TREATMENT, AIMED AT ADDRESSING ŃSLPP CONCERNS (SPECIFICALLY CONDITION C51), NOW INCLUDES REVISED ARTICULATION, AKIN TO THAT APPROVED IN THE DETERMINATION HOR DA 86/22-1 C NO ARTICULATION, AKIN TO THAT APPROVED IN THE DETERMINATION FOR DA 86/22 - LEC NO. 2022/165233. THIS INVOLVES A CENTRAL INDENTATION, WITH ADJACENT BALCONIES MIRRORED TO ENSURE A SYMMETRICAL DESIGN ALONG THE SOUTHERN BOUNDARY FACING BEN BOYD ROAD. ADDITIONALLY, THE WINDOWS AND SURROUNDING FEATURES HAVE BEEN UPDATED IN HARMONY WITH THESE BALCONY ALTERATIONS.

·····

DRAWING TITLE:

2,780

26.805

GROUND FLOOR PLAN PROJECT ADDRESS: 96-98 BEN BOYD RD, NEUTRAL BAY NSW 2089

LOT / SECTION / DP NO .: LOT A DP348364 & SP61709



SCALE: 1:200@A3 DH ISSUE DATE:

DRAWN BY:

CHECKED: MW REVISION:

Н


14/12/2023 PROJECT NUMBER: 21-095

DWG NUMBER: DA 2002

#### AIDOP NO 3 PTY LTD SUITE 506, LEVEL 5, 55 MILLER ST, PYRMONT NSW 2009

REF: Alclumes/BMA Projects/21-096 Ben Boyd Post Panel Meeting/21-095 Ben Boyd Rd Neutr:

#### ATTACHMENT TO LPP04 - 03/04/24

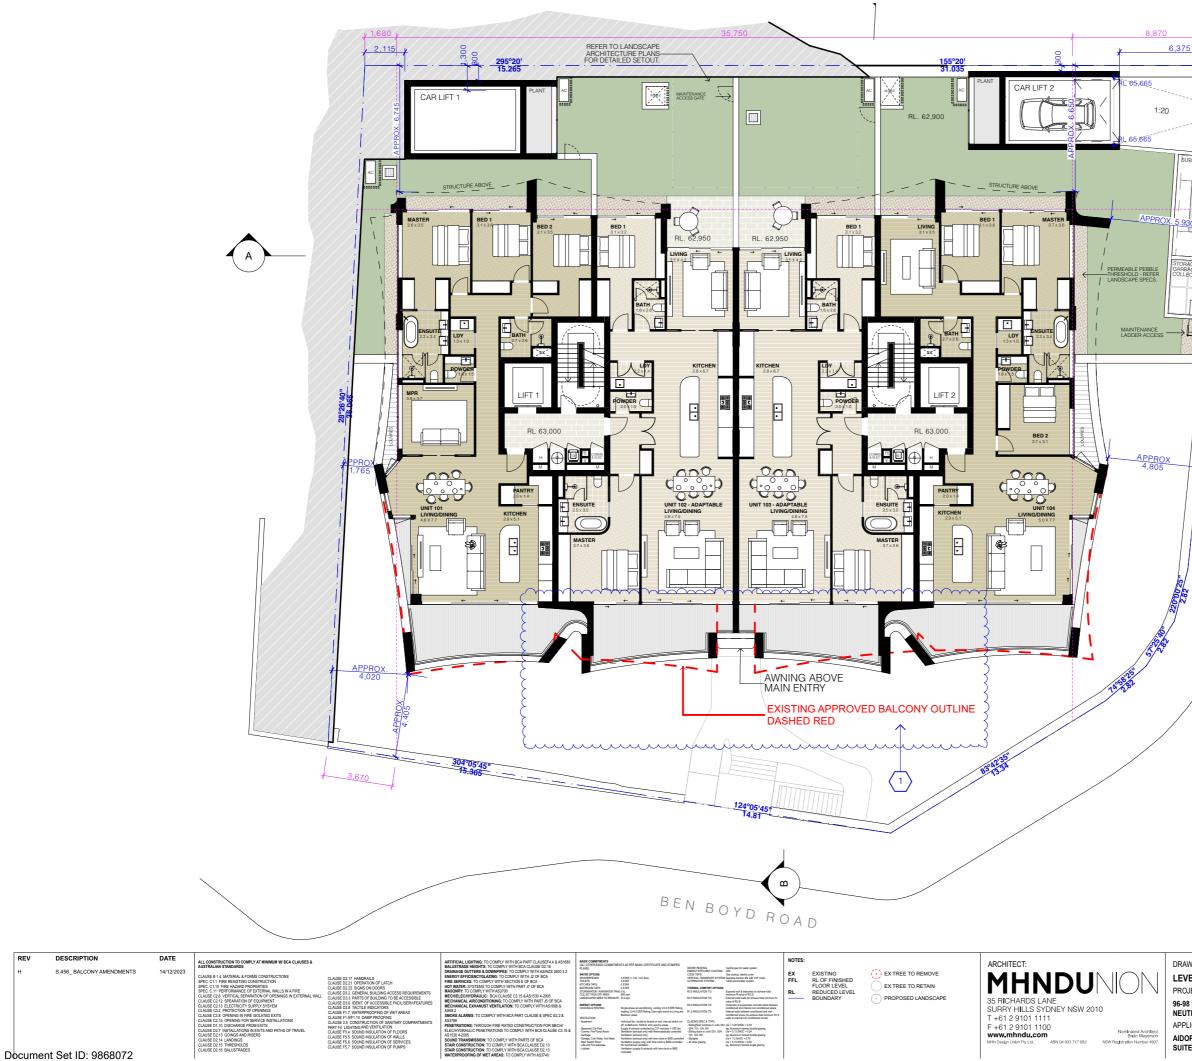

Version: 1, Version Date: 17/01/2024

Page 80



DRAWING TITLE: LEVEL 1 FLOOR PLAN PROJECT ADDRESS: 96-98 BEN BOYD RD, NEUTRAL BAY NSW 2089 APPLICANT: AIDOP NO 3 PTY I TD SUITE 506, LEVEL 5, 55 MILLER ST, PYRMONT NSW 2009

Xx

≪ X RL 65,630

¥\_630 Х

6


RL 66,000

LOT / SECTION / DP NO .: LOT A DP348364 & SP61709

SCALE: DRAWN BY: CHECKED: 1:200@A3 DH MW ISSUE DATE: REVISION: 14/12/2023 Н PROJECT NUMBER: DWG NUMBER: 21-095 DA 2003

REF: No

#### ATTACHMENT TO LPP04 - 03/04/24

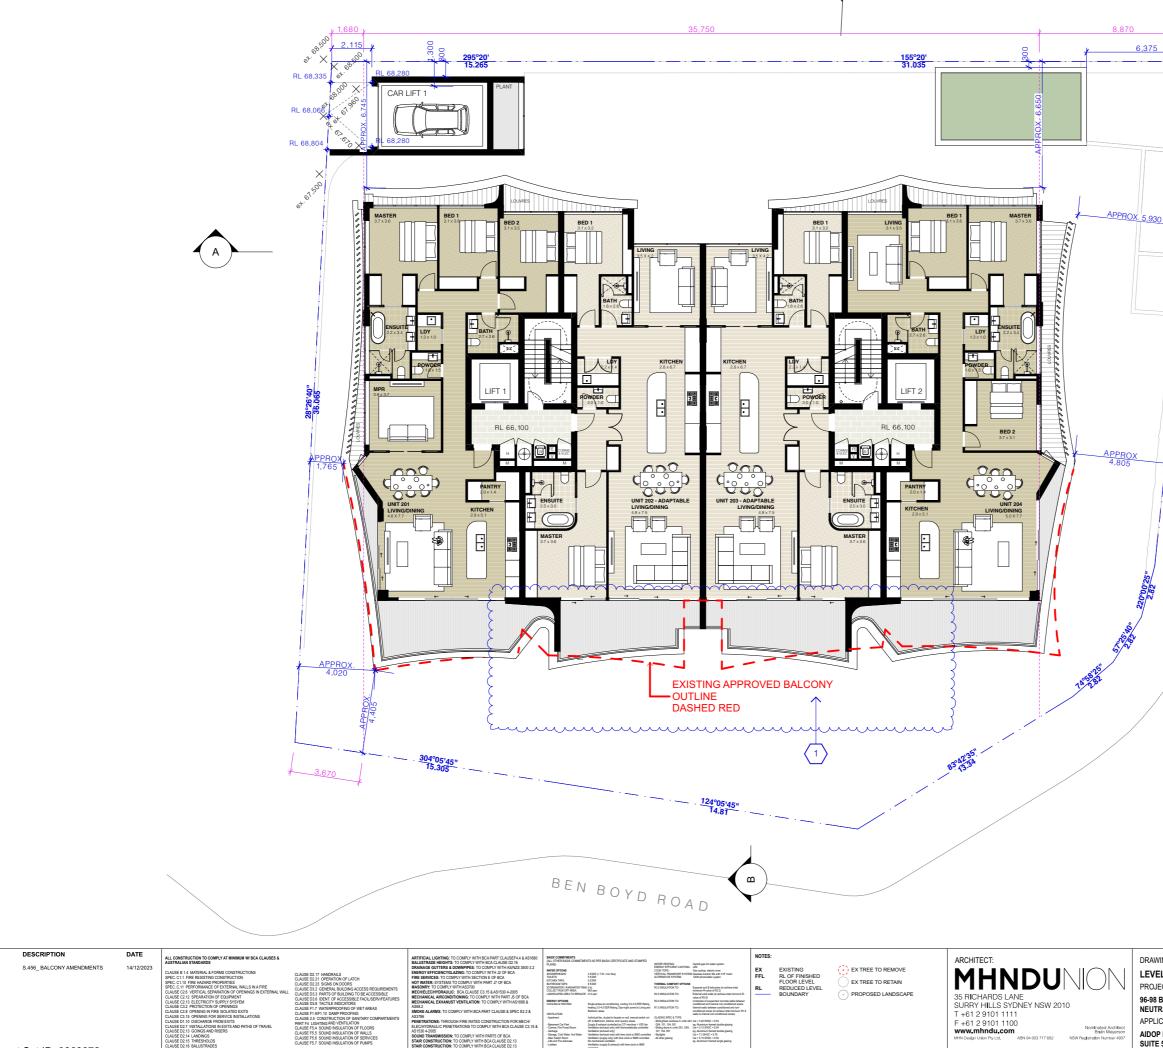

MPLY WITH PARTS OF BCA MPLY WITH BCA CLAUSE D2.1

Document Set ID: 9868072 Version: 1, Version Date: 17/01/2024

REV

 $\Box$ 26.805  $\triangleleft$  $\bigcirc$  $\square$  $\Box$  $\succ$  $\bigcirc$  $\square$ Z Ш  $\Box$ **REV H: DESIGN AMENDMENTS TO** ADDRESS CONDITIONS C51 SET OUT IN S S 4.56 86/22/2 SOUTHERN FACADE BALCONIES - DESIGN SOUTHERN FACADE BALCONIES - DESIGN AMENDMENTS: IN LINE WITH THE UPDATED APARTMENT LAYOUTS APPROVED UNDER S4.56 (86/22/2), BALCONY GEOMETRY HAS BEEN RECONFIGURED. THE PROPOSED FAÇADE TREATMENT, AIMED AT ADDRESSING NSLPP CONCERNS (SPECIFICALLY CONDITION C51), NOW INCLUDES REVISED ARTICULATION, AKIN TO THAT APPROVED IN THE DETERMINATION FOR DA 86/22 - LEC NO. ARTICULATION, AKIN TO THAT APPROVED IN THE DETERMINATION FOR DA 86/22 - LEC NO. 2022/165233. THIS INVOLVES A CENTRAL INDENTATION, WITH ADJACENT BALCONIES MIRRORED TO ENSURE A SYMMETRICAL DESIGN ALONG THE SOUTHERN BOUNDARY FACING BEN BOYD ROAD. ADDITIONALLY, THE WINDOWS AND SURROUNDING FEATURES HAVE BEEN UPDATED IN HARMONY WITH THESE BALCONY ALTERATIONS.

DRAWING TITLE: LEVEL 2 FLOOR PLAN PROJECT ADDRESS: 96-98 BEN BOYD RD, NEUTRAL BAY NSW 2089 APPLICANT: AIDOP NO 3 PTY I TD

LOT / SECTION / DP NO .: LOT A DP348364 & SP61709  $(\mathcal{D})$ 

SCALE: 1:200@A3 DH ISSUE DATE: 14/12/2023 PROJECT NUMBER: 21-095

DRAWN BY: CHECKED: MW REVISION:

Н DWG NUMBER: DA 2004

## SUITE 506, LEVEL 5, 55 MILLER ST, PYRMONT NSW 2009



н	S466_BALCONY AMENDMENTS	DATE 14/12/2023	ALL CONSTRUCTION TO COMPLY AT MININUM WECA CLAUSES & AUSTRULIAN STANDARDS CALLES 14. MARCHARDS CONSTRUCTIONS SPEC. C11 FIRE RESISTING CONSTRUCTION SPEC. C11 FIRE RESISTING CONSTRUCTION CONSTRUCTION OF COMPLICITIES IN SPECIAL CALLES C11 SPECTION OF COMPLICITIES INTERNAL WALL CALLES C11 SPECTION OF COMPLICITIES CALLES C11 SPECTIONES COMPLICITIES CALLES C11 SPECTIONES CALLES C11 SPECTIONES CALL	CLAUSE D2 17 INVERTIALS CLAUSE D2 17 OPERATION OF LATCH CLAUSE D2 23 OPERATION OF LATCH CLAUSE D2 23 OPERAL BULLONG ACCESS REQUIREMENTS CLAUSE D3 2 OPERAL BULLONG ACCESS REQUIREMENTS CLAUSE D3 2 OPERAL BULLONG ACCESS REQUIREMENTS CLAUSE D3 17 WITH PROFOND OF WITH AREAS CLAUSE D3 17 WITH PROFOND OF WITH AREAS CLAUSE D3 17 WITH DAMP PROFOND OF COMPRIMENTS DAMPET FLUETMEND VISITILIATION OF FLOORS CLAUSE F5 4 SOUND INSLATION OF PLOORS CLAUSE F5 4 SOUND INSLATION OF PLOORS CLAUSE F5 4 SOUND INSLATION OF PLORES CLAUSE F5 7 SOUND INSLATION OF PLORES	ARTIFICIAL LIGHTING: TO COMPLY WITH BCA PART CLAUSEF44 & AS1960 BALUSTRAC HEIDRETS TO COMPLY WITH BCA CLAUSE CD 19 DOLANGUE CUTTERS SOLOWING: TO COMPLY WITH AGA CLAUSE CD 19 PRE SERVICES TO COMPLY WITH SECTION & OF PART WITH COMPLY THIS SOLOWING WITH AND TO PECA WITH VIEWE STORED TO COMPLY WITH SECTION & OF PART WITH VIEWE STORED TO COMPLY WITH AND TO PECA WITH VIEWE STORED WITH ADDR TO COMPLY WITH AND TO PECA WITH VIEWE STORED WITH ADDR TO COMPLY WITH AND TO PECA WITH ADDR STORED WITH ADDR TO COMPLY WITH ADDR TO PECA WITH ADDR STORED WITH ADDR TO COMPLY WITH ADDR TO PECA WITH ADDR STORED WITH ADDR TO COMPLY WITH ADDR TO PECA WITH ADDR STORED WITH ADDR TO COMPLY WITH ADDR TO PECA WITH ADDR STORED WITH ADDR TO COMPLY WITH ADDR TO PECA ADDR TO WITH ADDR TO COMPLY WITH ADDR TO PECA ADDR TO WITH ADDR TO COMPLY WITH ADDR TO CAUSE & STORE COMPLY THAT ADDR TO COMPLY WITH ADDR TO COMPLY WITH ADDR TO COMPLY WITH ADDR TO COMPLY WITH ADDR TO COMPLY WITH ADDR TO COMPLY WITH ADDR TO WITH ADDR TO COMPLY WITH ADDR TO COMPLY WITH ADDR TO WITH ADDR TO COMPLY WITH ADDR TO CAUSE & STORE COMPLY ADDR TO WITH ADDR TO COMPLY WITH ADDR TO COMPLY WITH ADDR TO ADDR TO WITH ADDR TO COMPLY WITH ADDR TO COMPLY WITH ADDR TO ADDR TO WITH ADDR TO COMPLY WITH ADDR TO COMPLY WITH ADDR TO ADDR TO WITH ADDR TO COMPLY WITH ADDR TO CAUSE & STORE STARE CONSTRUCTION TO COMPLY WITH ADDR TO CAUSE & STORE STARE CONSTRUCTION TO COMPLY WITH ADDR TO CAUSE CD STORE STARE CONSTRUCTION TO COMPLY WITH ADDR TO CAUSE CD STORED TO ADDR TO WITH ADDR TO COMPLY WITH ADDR TO CAUSE CD STORED TO ADDR TO WITH ADDR TO COMPLY WITH ADDR TO CAUSE CD STORED TO STARE CONSTRUCTION TO COMPLY WITH ADDR STORED TO ADDR TO CONSTRUCTION TO COMPLY WITH ADDR STORED TO ADDR TO CONSTRUCTION TO COMPLY WITH ADDR STORED TO ADDR TO TAUNAMENT ADDR TO COMPL	Addit COMMITMENTS PLL OFFER SADE COMMIT PLANE) WHETE OFFICE NOTICES NO	660 sqm	ALTERNATINE SYSTEM THEMAL CONFORT OF THE ISS INCLUSION TO IR 25 INCLUSION TO INCLUSION TO INCLUSIO	Gas cookop, electric oven ITEM: Gearless Inscion IIIs with VVF roctor T2KII photoxolaic xyslem	NOTES: EX FFL RL	EXISTING RLOFFINISHED FLOAR LEVEL REDUCED LEVEL BOUNDARY	EX TREE TO REMOVE     EX TREE TO RETAIN     PROPOSED LANDSCAPE	ARCHITECT: <b>MHNDU</b> 35 RICHARDS LANE SURRY HILLS SYDNEY NSW 2010 T +61 2 9101 1110 F +61 2 9101 1100 <b>WWW.mhndu.com</b> MHOMGRUKAN PYLEL ARI PA 003 717 682 NS	Nominated Achilect Bhill Mayatton SW Reglanston Numcer 4907	DRAWING LEVEL 3 PROJECT 96-98 BEN NEUTRAL APPLICAN AIDOP NO SUITE 500
Document	t Set ID: 9868072					- Lifts and Fire staircase	No mechanical ventilation Ventilation (supply & exhaust) with time clock or BMS		eg, Aluminum hanned single glucing					Sw Heyes alor Humber 4907	SUITE 506
Version: 1	, Version Date: 17/01/2	2024													

WING TITLE: EL 3 FLOOR PLAN JECT ADDRESS: I B BEN BOYD RD, I IRAL BAY NSW 2089 JCANT: IP NO 3 PTY LTD E 606 J FUTL C COMMENT

LOT / SECTION / DP NO.: LOT A DP348364 & SP61709 
 SCALE:
 DRAWN BY:

 1:200@A3
 DH

 ISSUE DATE:
 14/12/2023

 PROJECT NUMBER:

BY: CHECKED: MW REVISION:

MW REVISION: **H** DWG NUMBER:

DA 2005

P NO 3 PTY LTD E 506, LEVEL 5, 55 MILLER ST, PYRMONT NSW 2009 21-095 REF: Volumes/BMA Projects/21-095 Ben Boyd Rd Neutral BayWO Post Parel Meding/21-095 Ran Rowd Rd Neutral Baywo





DRAWING TITLE: LEVEL 4 FLOOR PLAN PROJECT ADDRESS: 96-98 BEN BOYD RD, NEUTRAL BAY NSW 2089 APPLICANT: AIDOP NO 3 PTY I TD SUITE 506, LEVEL 5, 55 MILLER ST, PYRMONT NSW 2009

LOT / SECTION / DP NO .: LOT A DP348364 & SP61709  $\bigotimes$ 

1:200@A3 DH MW ISSUE DATE: 14/12/2023 PROJECT NUMBER: 21-095 DA 2006

DRAWN BY:

REVISION: Н DWG NUMBER:

CHECKED:


SCALE:


# ALONG THE SOUTHERN BOUNDARY FACING BEN BOYD ROAD. ADDITIONALLY, THE WINDOWS AND SURROUNDING FEATURES HAVE BEEN UPDATED IN HARMONY WITH THESE BALCONY ALTERATIONS.

**REV H: DESIGN AMENDMENTS TO** ADDRESS CONDITIONS C51 SET OUT IN S 4.56 86/22/2 SOUTHERN FACADE BALCONIES - DESIGN AMENDMENTS: IN LINE WITH THE UPDATED APARTMENT LAYOUTS APPROVED UNDER S4.56 (86/22/2), BALCONY GEOMETRY HAS BEEN RECONFIGURED. THE PROPOSED FAÇADE TREATMENT, AIMED AT ADDRESSING ŃSLPP CONCERNS (SPECIFICALLY CONDITION C51), NOW INCLUDES REVISED ARTICULATION, AKIN TO THAT APPROVED IN THE DETERMINATION FOR DA 86/22 - LEC NO. 2022/165233. THIS INVOLVES A CENTRAL INDENTATION, WITH ADJACENT BALCONIES MIRRORED TO ENSURE A SYMMETRICAL DESIGN ALONG THE SOUTHERN BOUNDARY FACING BEN



Page 83

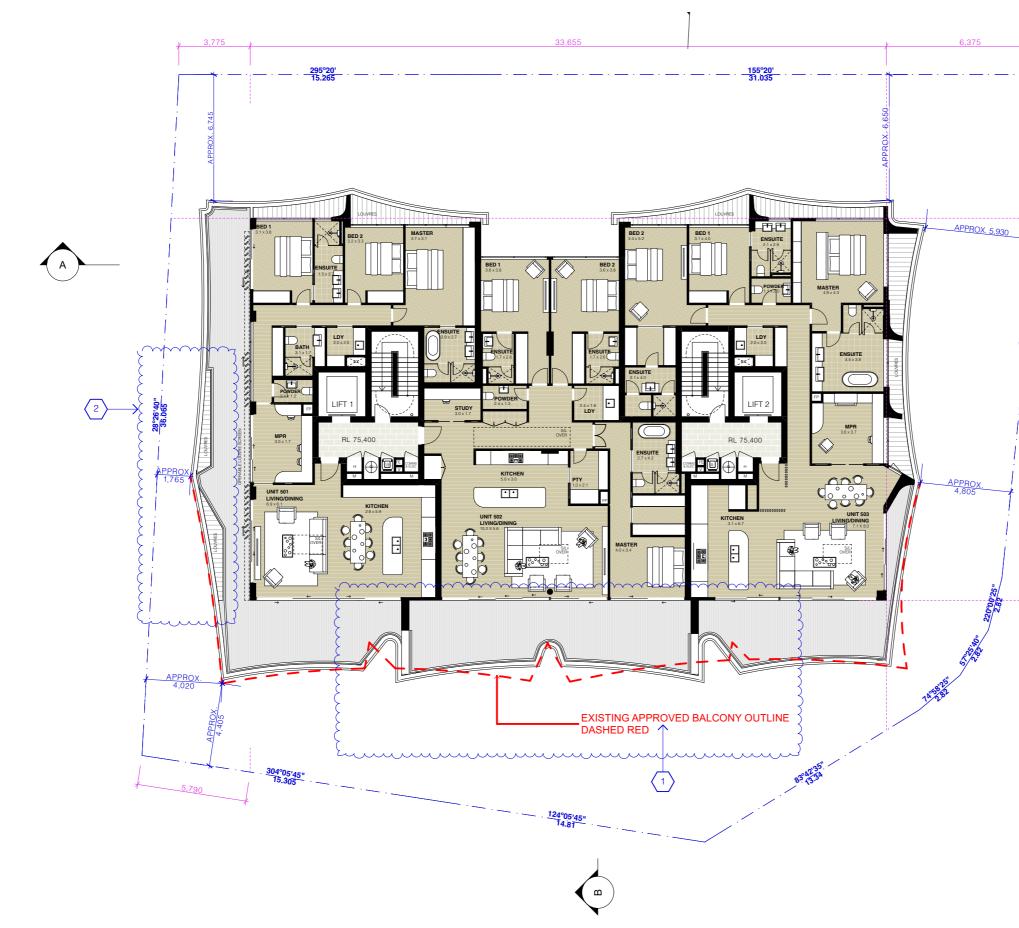

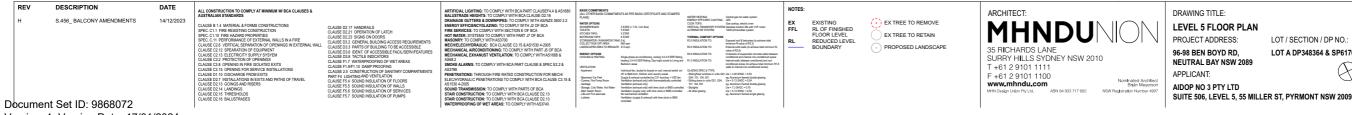

11°16'20 26.805 **REV H: DESIGN AMENDMENTS TO ADDRESS CONDITIONS C51 SET** OUT IN S 4.56 86/22/2 SOUTHERN FACADE BALCONIES - DESIGN AMENDMENTS: IN LINE WITH THE UPDATED APARTMENT LAYOUTS APPROVED UNDER S4.56 (86/22/2), BALCONY GEOMETRY HAS BEEN RECONFIGURED. THE PROPOSED FAÇADE TREATMENT, AIMED AT ADDRESSING NSLPP CONCERNS (SPECIFICALLY CONDITION C51), NOW INCLUDES REVISED ARTICLU ATION AKIN TO THAT APPROVED IN C5 1), NUW INCLUDES HEVISED ARTICULATION, AKIN TO THAT APPROVED IN THE DETERMINATION FOR DA 86/22 - LEC NO. 2022/165233. THIS INVOLVES A CENTRAL INDENTATION, WITH ADJACENT BALCONIES MURPOPED TO FUNCTION MIRRORED TO ENSURE A SYMMETRICAL DESIGN ALONG THE SOUTHERN BOUNDARY FACING BEN BOYD ROAD. ADDITIONALLY, THE WINDOWS AND SURROUNDING FEATURES HAVE BEEN UPDATED IN HARMONY WITH THESE BALCONY LEVEL 5 WESTERN BALCONY- DESIGN 2. AMENDMENTS: BALCONY GEOMETRY RECONFIGURED TO BE AKIN TO THAT APPROVED IN THE DETERMINATION FOR DA 86/22 - LEC NO. 2022/165233. THE BALUSTRADE ALONG THE WESTERN EDGE HAS BEEN ADJUSTED TO FOLLOW THE AMENDED OUTLINE.

DRAWING TITLE: LEVEL 5 FLOOR PLAN PROJECT ADDRESS: 96-98 BEN BOYD RD, NEUTRAL BAY NSW 2089 APPLICANT: AIDOP NO 3 PTY I TD

LOT / SECTION / DP NO .: LOT A DP348364 & SP61709  $\bigotimes$ 

SCALE: 1:200@A3 DH ISSUE DATE:


14/12/2023 PROJECT NUMBER: 21-095

DRAWN BY: CHECKED: MW

REVISION: Н


DWG NUMBER: DA 2007

Page 84

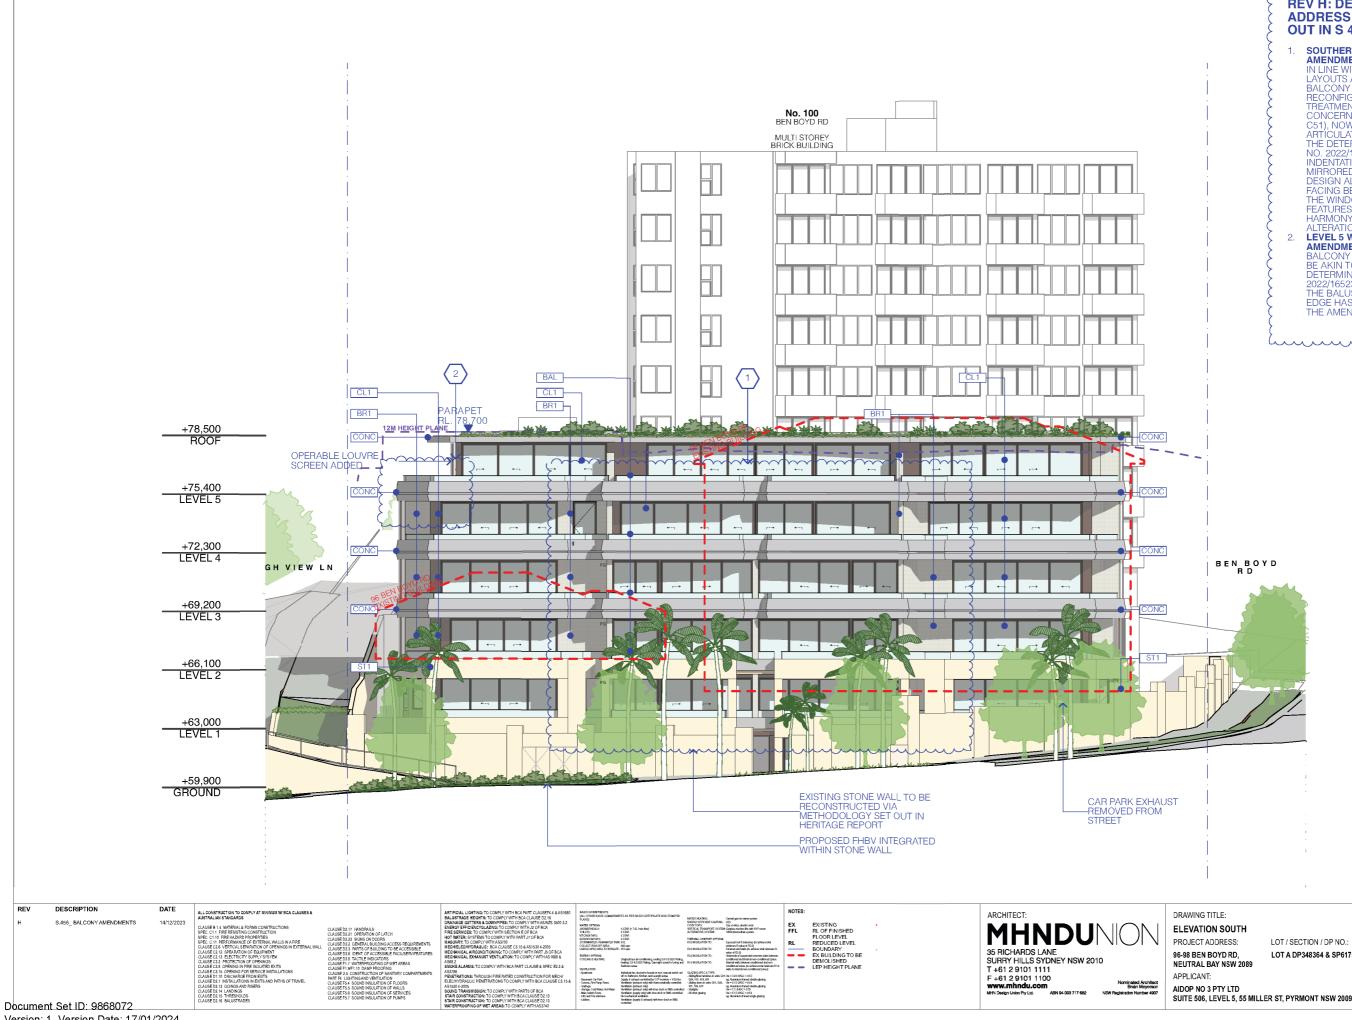

Version: 1, Version Date: 17/01/2024

REV

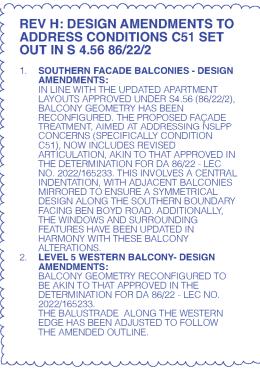

LOT / SECTION / DP NO .: LOT A DP348364 & SP61709 SCALE: 1:200@A3 ISSUE DATE:

PROJECT NUMBER:

14/12/2023

DRAWN BY: DH

CHECKED: MW REVISION:

Н

DWG NUMBER DA 3001

21-095

#### 96-98 BEN BOYD RD, **NEUTRAL BAY NSW 2089**

DECEMBER, 2023

DWG NO.	DRAWING NAME	REVISION
DA 0000	COVERPAGE	Н
DA 1002	SITE PLAN	Н
DA 2002	GROUND FLOOR PLAN	Н
DA 2003	LEVEL 1 FLOOR PLAN	Н
DA 2004	LEVEL 2 FLOOR PLAN	Н
DA 2005	LEVEL 3 FLOOR PLAN	Н
DA 2006	LEVEL 4 FLOOR PLAN	Н
DA 2007	LEVEL 5 FLOOR PLAN	Н
DA 3001	ELEVATION SOUTH	Н
DA 3003	ELEVATION WEST	Н
DA 3101	SECTION B	Н
DA 9102	LANDSCAPE CALCULATION	Н
DA 9103	SITE COVERAGE DIAGRAM	Н
DA 9302	NOTIFICATION PLAN - 01	Н
DA 9303	NOTIFICATION PLAN - 02	Н

#### ATTACHMENT TO LPP04 - 03/04/24

# REV H: DESIGN AMENDMENTS TO ADDRESS CONDITIONS C51 SET OUT IN S 4.56 86/22/2 SOUTHERN FACADE BALCONIES - DESIGN AMENDMENTS: IN LINE WITH THE UPDATED APARTMENT LAYOUTS APPROVED UNDER S4.56 (86/22/2), BALCONY GEOMETRY HAS BEEN RECONFIGURED. THE PROPOSED FACADE TREATMENT, AIMED AT ADDRESSING NSLPP CONCERNS (SPECIFICALLY CONDITION C51), NOW INCLUDES REVISED ARTICULATION, AKIN TO THAT APPROVED IN THE DETERMINATION FOR DA 86/22 - LEC NO. 2022/165233. THIS INVOLVES A CENTRAL INDENTATION, WITH ADJACENT BALCONIES MIRRORED TO ENSURE A SYMMETRICAL DESIGN ALONG THE SOUTHERN BOUNDARY FACING BEN BOYD ROAD. ADDITIONALLY, THE WINDOWS AND SURROUNDING FEATURES HAVE BEEN UPDATED IN HARMONY WITH THESE BALCONY ALTERATIONS. 1 2. LEVEL 5 WESTERN BALCONY- DESIGN AMENDMENTS: BALCONY GEOMETRY RECONFIGURED TO BE AKIN TO THAT APPROVED IN THE DETERMINATION FOR DA 86/22 - LEC NO. 2022/165233. THE BALUSTRADE ALONG THE WESTERN EDGE HAS BEEN ADJUSTED TO FOLLOW THE AMENDED OUTLINE.



# CATIO Ξ 56 CTION 4


DRAWING TITLE: COVERPAGE PROJECT ADDRESS: 96-98 BEN BOYD RD, NEUTRAL BAY NSW 2089 APPLICANT: AIDOP NO 3 PTY I TD SUITE 506, LEVEL 5, 55 MILLER ST, PYRMONT NSW 2009





SCALE: DRAWN BY: CHECKED: 1:1@A3 DH MW ISSUE DATE: REVISION: 14/12/2023 н PROJECT NUMBER: DA 0000 21-095

DWG NUMBER:

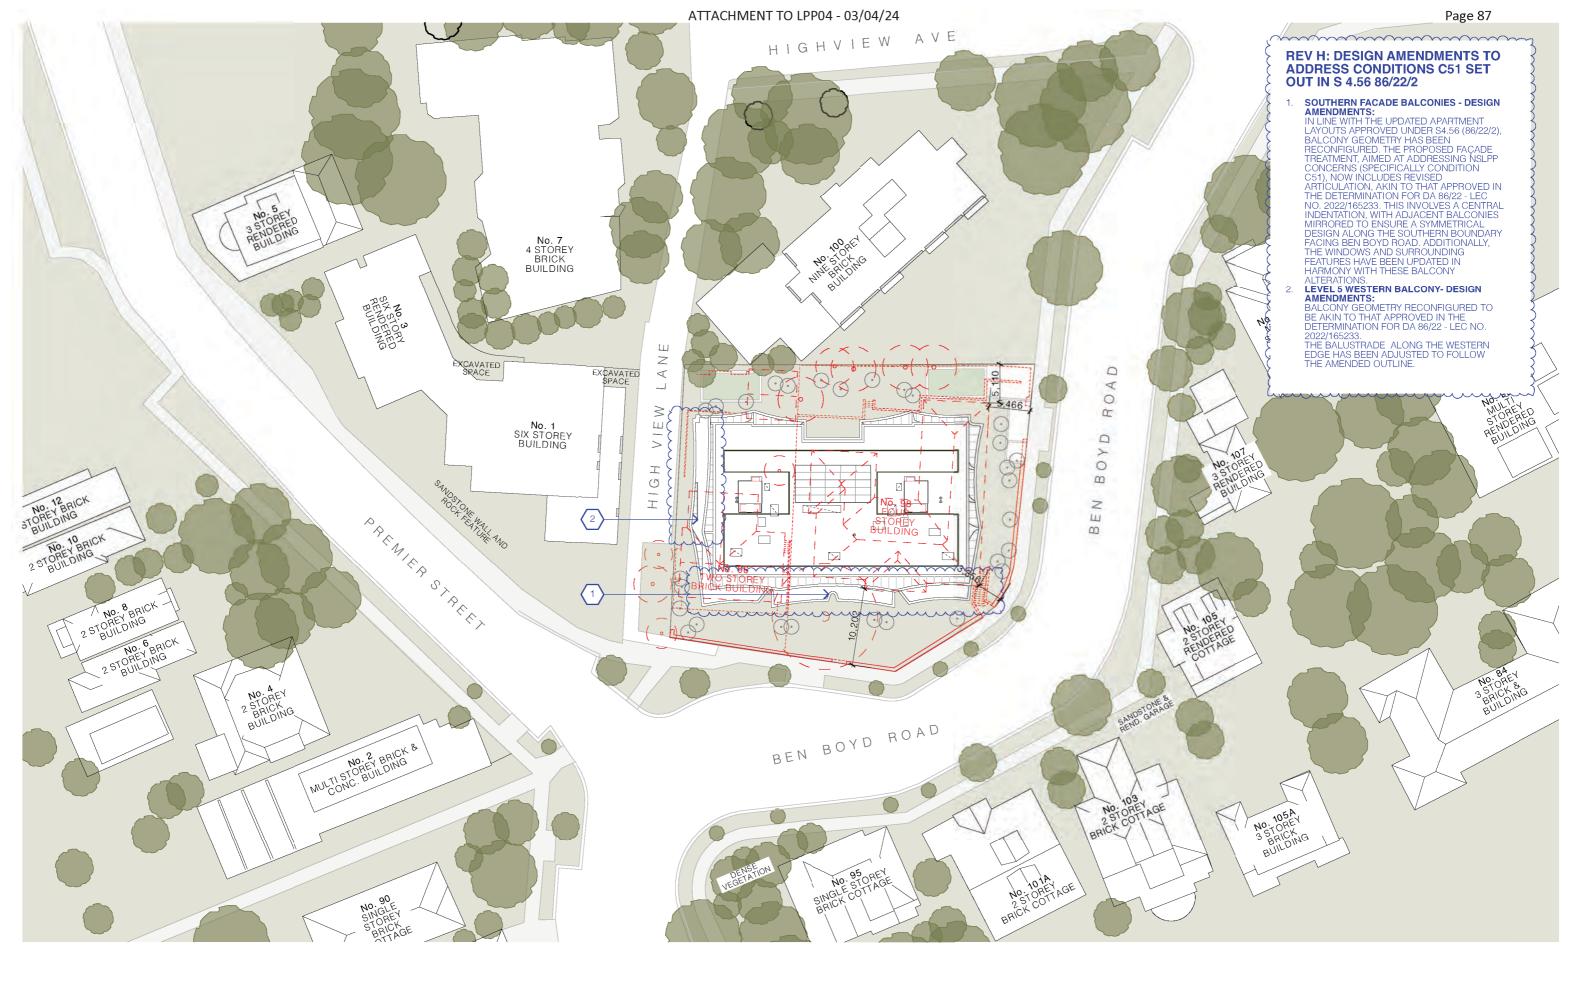

Do		DATE 15/2/2024 2024	ALL CONSTRUCTION TO COMPLY AT INIVIAUM W BOD CLAUSES & AUSTRULAN STANDARDS CLAUSE 51 4 WERDLA STOME CONSTRUCTIONS SPEC. C11 FIRE RESISTING CONSTRUCTION SPEC. C11 FIRE RESISTING CONSTRUCTION SPEC. C11 FIRE RESISTING CONSTRUCTION SPEC. C11 FIRE RESISTING CONSTRUCTION CLAUSE C2 & SPECTICAL SERVICING WILLISM A FIRE CLAUSE C2 & SPECTICAL SERVICING WILLISM A FIRE CLAUSE C2 & SPECTICAL SERVICING FIRE CLAUSE C2 & SPECTICAL SERVICING TO CHEMINGS CLAUSE C2 & PORTICAL SERVICING WILLISM A FIRE CLAUSE C2 & PORTECTION OF OPENINGS CLAUSE C2 & PORTECT	CLUSE D3 17 HANDRALS CLUSE D3 17 HANDRALS CLUSE D3 10 SPRINTIK OF LATCH CLUSE D3 10 SPRINTIK D1 LINE ACCESSING CLUSE D3 10 SPRINTIK D1 LINE ACCESSING CLUSE D3 10 CHT CACCESSING EXCLUSE VIETNIES CLUSE D3 10 CHT CACCESSING CACCESSING VIETNIES CLUSE D3 10 CHT CACCESSING CACCESSING VIETNIES CLUSE D3 10 CHT CACESSING VIETNIES CLUSE D3 10 CHT CACESSI	ARTIROLAL LIGHTING-TO COMPLY WITH BCA PMET CLAURER 44 A 65 960 BALLET BLACK REIGHTS TO COMPLY WITH BCA CLAURE DO 16 DEALET BLACK REIGHTS TO COMPLY WITH BCA CLAURE DO 16 DEALET BLACK REIGHTS TO CLAURY WITH BLACE DATA INTEREMENT SPECIAL DATA DATA DATA DATA DATA INTEREMENT SPECIAL DATA DATA DATA DATA DATA DATA DES DOCUMENT MENTIONE DO PACA MERICES TO COMPLY WITH BCA CLAURE DATA DATA DES DOCUMENTS TO CLAURE DATA DATA DES DOCUMENTS TO CLAURE DATA DATA DES DOCUMENTS DOCUMENTS DATA DATA DATA DES DOCUMENTS DOCUMENTS DATA DATA DATA DES DOCUMENTS DOCUMENTS DATA DATA DATA DATA DATA DATA DATA DATA DATA	PADI GOVERTIERES (AL OTHER ACE CAMERING (AL OTHER ACE	HATE OF TELESCO CETTURATENDES SENT DE 1 (1977) - TALINA MON 2 (1977) 2 (1	ALTERNATING STREAM THEMAL CONFORT OFFIC RESIDENTIATION TO: RESIDENTIATION TO: RESIDENTIATION TO: A RESIDENTIATION TO: GUCENG SPECIA TIPE - Sideghand Waldows Interna- Coll Coll, No. 50, 50 - 20, 50, 60 - 30, 50, 60 - 30, 50, 60	Gas codrop, doctio ovan STBM: Gaalisus traction litte with WF notor S2NV photovalnik system	NOTES: EX FFL RL	EXISTING RL OF RINSHED RL OR LEVEL ROUNDARY EX BUILDING TO BE DEMOLISHED	EX TREE TO REMOVE EX TREE TO RETAIN	ARCHITECT: <b>MHN</b> 35 RICHARDS L SURRY HILLS ST 1 +61 2 9101 11 WWW.mhndu.cor Meth Deep Line FyLie	ANE /DNEY NSW 20 11 00	DRAWII SITE F PROJEI 96-98 B NEUTR APPLIC AIDOP SUITE S

 RAWING TITLE:

 TE PLAN

 ROJECT ADDRESS:
 LOT /

 -98 BEN BOYD RD,
 LOT /

 EUTRAL BAY NSW 2089
 PPLICANT:

 DOP NO 3 PTY LTD
 LOT /



1:500@A3 DH ISSUE DATE: 15/2/2024 PROJECT NUMBER: **21-095** 


SCALE:

DRAWN BY: CHECKED: DH MW REVISION: H

MW REVISION: H DWG NUMBER: DA 1002

ITE 506, LEVEL 5, 55 MILLER ST, PYRMONT NSW 2009

REF: BIMcloud: bcb-20 - BIMcloud Basic for Archicad 20/21-096 Ben Boyd Rd Neutral Bay - S456\_H

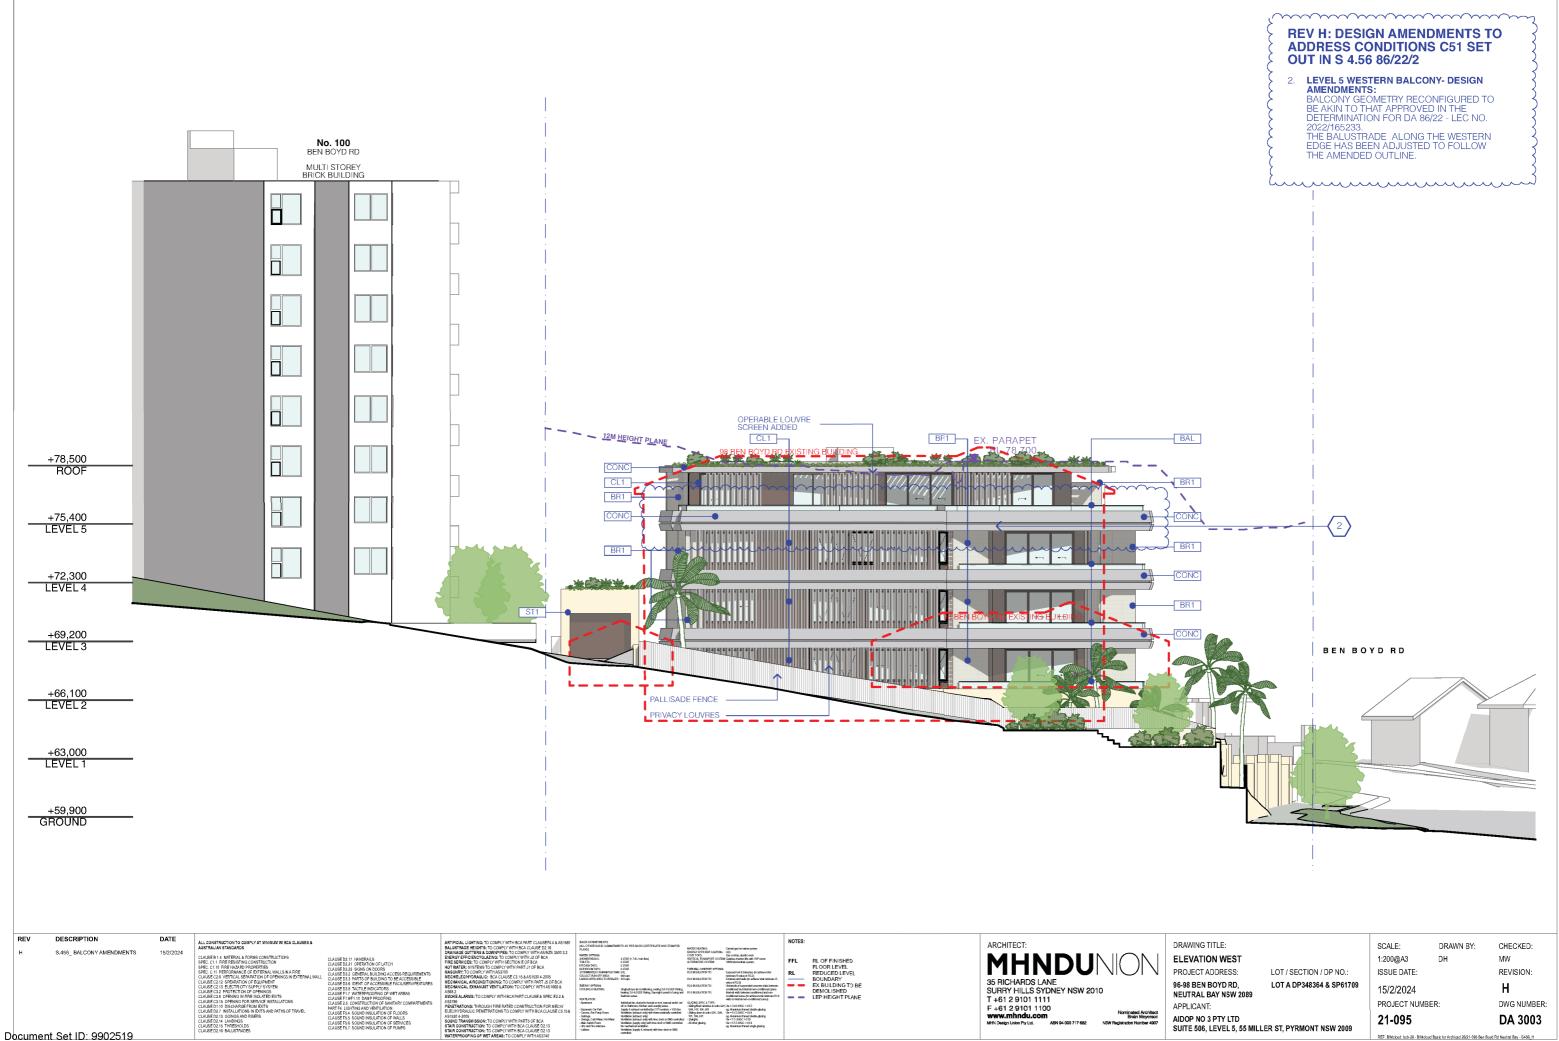


Version: 1, Version Date: 16/02/2024


# LANDSCAPE CALCULATION

SITE AREA	1,699.35 m <sup>2</sup>		
	CONTROL	APPROVED S34	PROPOSED
DEEP SOIL	118.95 m² 7.00%	369 m² 21.7%	361 m² 21.2%
LANDSCAPED AREA	-	704 m <sup>2</sup> 41.4%	704 m² 41.4%
ADDITIONAL LANDSCAPED AREA NOT INCLUDED IN LANDSCAPED AREA			
- ROOF	-	<b>41</b> 5 m <sup>2</sup> 24.4%	<b>41</b> 5 m² 24.4%
NOTE: LANDSCAPING I ENGINEERED DEEP SO BASEMENT. THIS IS IN I ON TOP OF DENSE RO	IL OVER THE LIEU OF PLANTING	à	
	IDSCAPED AREA		

DEEP SOIL

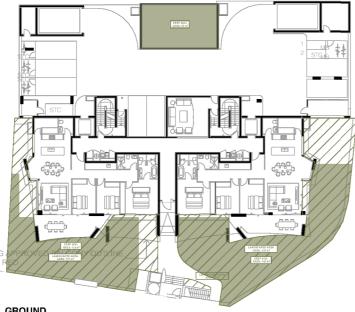

**GROUND** LANDSCAPE DIAGRAM

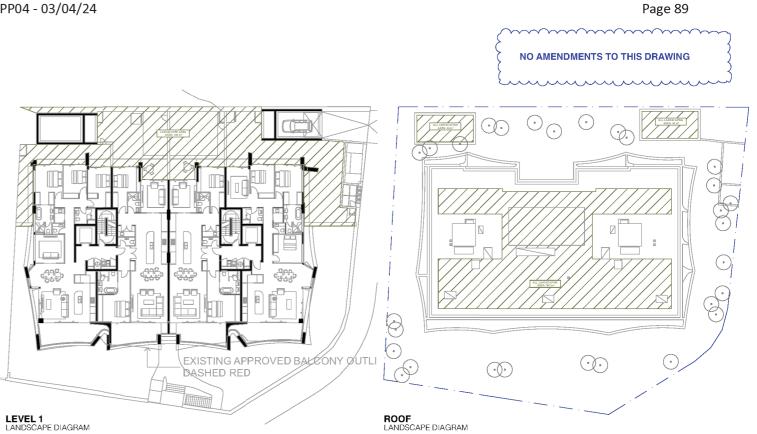



LANDSCAPE CALCULATION

LOT / SECTION / DP NO .:

LOT A DP348364 & SP61709  $\bigotimes$ 

AIDOP NO 3 PTY LTD SUITE 506, LEVEL 5, 55 MILLER ST, PYRMONT NSW 2009

SCALE: DRAWN BY: CHECKED: 1:500@A3 DH MW ISSUE DATE: REVISION: 15/2/2024 н PROJECT NUMBER: 21-095


DWG NUMBER: DA 9102

td Neutral Bay - S456 H

# SITE COVERAGE DIAGRAM

SITE AREA	1,699.35 m <sup>2</sup>							
	CONTROL	APPROVED S34	PROPOSED					
SITE COVERAGE	764.71 m²	825 m <sup>2</sup>	843 m <sup>2</sup>					
	45.00%	48.55%	49.61%					
UNBUILT AREA	254.90 m <sup>2</sup>	462 m <sup>2</sup>	440 m <sup>2</sup>					
	15.00%	27.54%	26.72%					



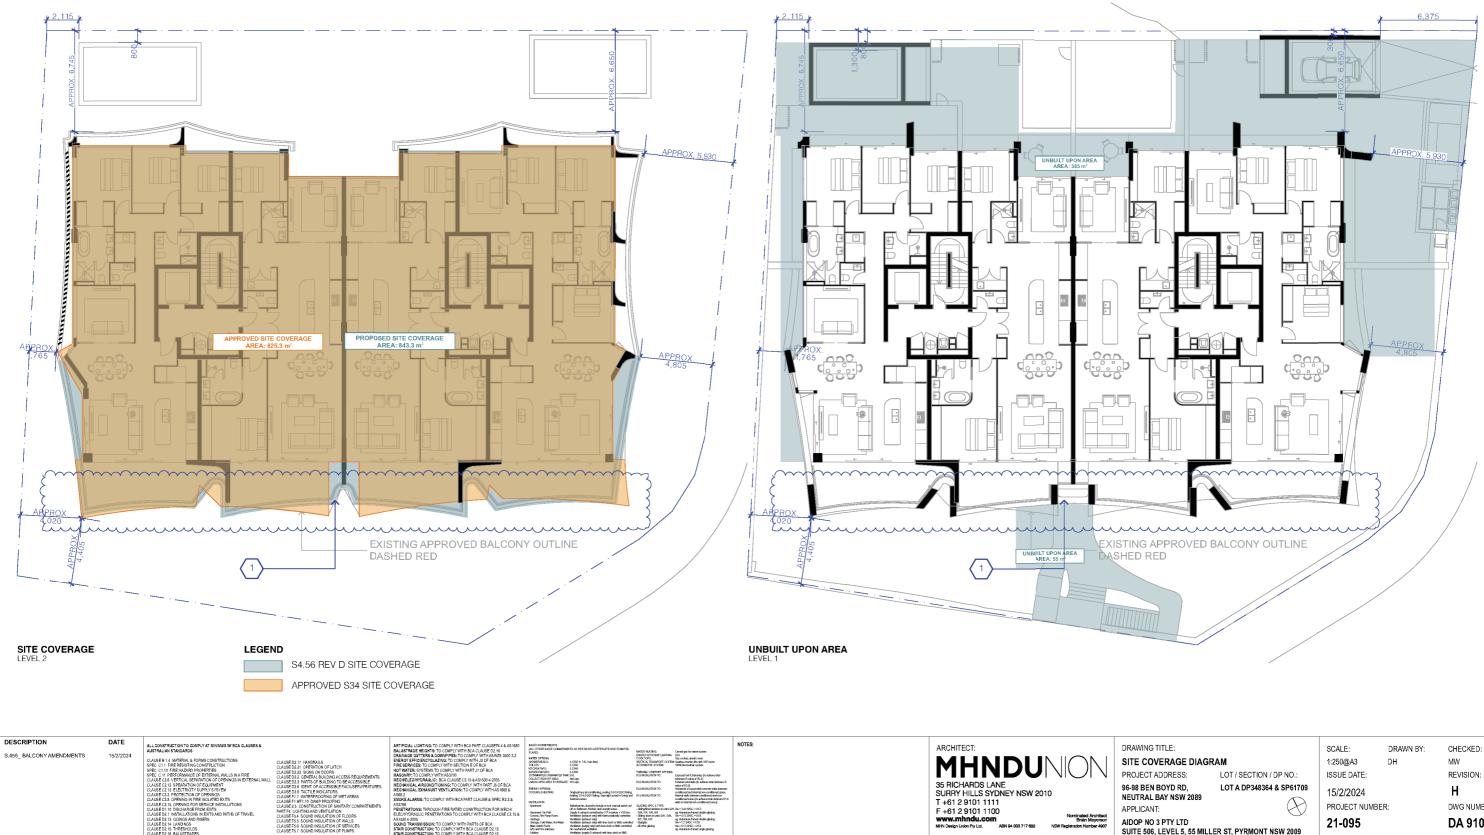

PARTS OF BCA BCA CLAUSE D2 13 BCA CLAUSE D2 13

Document Set ID: 9902519 Version: 1, Version Date: 16/02/2024

REV

# **REV H: DESIGN AMENDMENTS TO ADDRESS** CONDITIONS C51 SET OUT IN S 4.56 86/22/2 SOUTHERN FACADE BALCONIES - DESIGN AMENDMENTS: SOUTHERN FACADE BALCONIES - DESIGN AMENDMENTS: IN LINE WITH THE UPDATED APARTMENT LAYOUTS APPROVED UNDER S4.56 (86/22/2), BALCONY GEOMETRY HAS BEEN RECONFIGURED. THE PROPOSED FACADE TREATMENT, AIMED AT ADDRESSING NSLPP CONCERNS (SPECIFICALLY CONDITION C51), NOW INCLUDES REVISED ARTICULATION, AKIN TO THAT APPROVED IN THE DETERMINATION FOR DA 86/22 - LEC NO. 2022/165233. THIS INVOLVES A CENTRAL INDENTATION, WITH ADJACENT BALCONIES MIRRORED TO ENSURE A SYMMETRICAL DESIGN ALONG THE SOUTHERN BOUNDARY FACING BEN BOYD ROAD. ADDITIONALLY, THE WINDOWS AND SURROUNDING FEATURES HAVE BEEN UPDATED IN HARMONY WITH THESE BALCONY ALTERATIONS. HARMONY WITH THESE BALCONY ALTERATIONS.

REVISION: DWG NUMBER: 21-095 DA 9103 REF: BIMoloud: bcb-26 - BIMoloud Basic for Archicad 20/21-095 Ben Boyd Rd Neutral Bay - \$456 H

SUITE 506, LEVEL 5, 55 MILLER ST, PYRMONT NSW 2009


COVER PAGE 35 RICHARDS AVE SURRY HILLS NSW 2010 Document Set ID: 9868064 Version: 1, Version Date: 17/01/2024



Page 91

 Dwg
 1
 Rev
 Nominated Architect B.Meyerson

 Scale
 15/1/2024
 NSW Registration Number
 4907

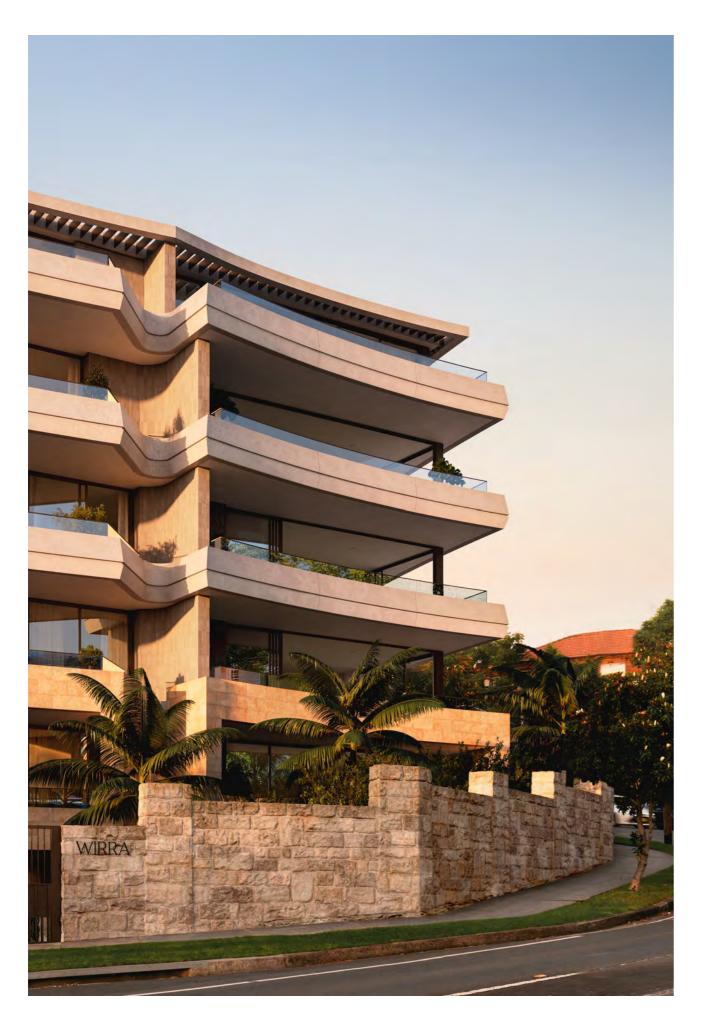

This brief report is presented to complement the recent S456 H submission and to illuminate the design evolution from the S34 approval as it relates specifically to the geometry and form of the South-facing balconies. As set out in our very first design report issued with the original DA, our ambition was to enhance the existing quality of the site by producing a high-quality architectural design which maximises residential amenity on a South-facing site and reduces bulk and scale through a refined massing and articulated approach.

We believe we have achieved this by creating an articulated sandstone base with apartments above, expressed through a minimal palette of concrete and off-white brickwork. Large curved scalloped balconies create a strong architectural language, while angles and refined precast walls achieve visual privacy. The building is further articulated to the southern facade with a series of indentations which reduce the overall bulk, mass, and scale with consideration to surrounding context, while maintaining views and outlook.


The design changes we have made to the South-facing balconies as a result of feedback from the NSLPP maintain a commitment to the building's aesthetic and structural integrity, and with a continued commitment to the original principles set forth in the original DA. The changes proposed in this revision are minor in nature, retaining the integrity of the massing and proportions approved post-S34, whilst enhancing spatial distribution along the façade. This design response is also complementary to the updated apartment layouts on levels 4 and 5, in accord with the S4.56 approval. This results in a more harmonious and visually appealing connection between the living spaces and their respective balconies, elevating the residential experience and magnifying the harbour views.

We also believe the revised approach presents a more streamlined, symmetrical aesthetic more in keeping with the pre-S34 design, with refinements such as the reintroduction of curved white brick walls to the balconies and curved indentations which were lost during the S34 process.

Enclosed are the comparative plans and images which narrate the design's progression. Each modification has been thoughtfully considered to enhance the spaces' functionality and comfort, whilst meticulously preserving the design intent and proportions of the original proposal.

We are confident that the design not only retains the design intent of the original S34 approval but also addresses the feedback provided by the NSLPP during the previous panel meeting. We believe that the revised design of the South-facing balconies upholds the Council's planning principles and will make a significant contribution to the architectural landscape of the area.

SUMMARY 35 RICHARDS AVE SURRY HILLS NSW 2010 Document Set ID: 9868064 Version: 1. Version Date: 17/01/2024

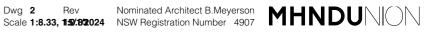


#### S34 APPROVED PERSPECTIVE




### S456 H PROPOSED PERSPECTIVE



#### S34 APPROVED BALCONY DIAGRAM

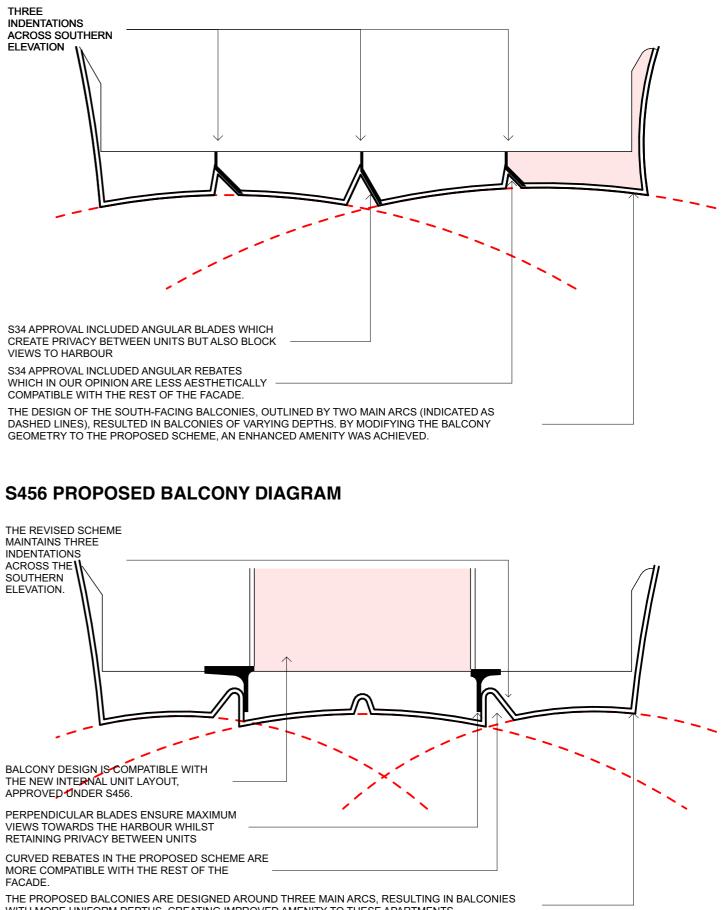


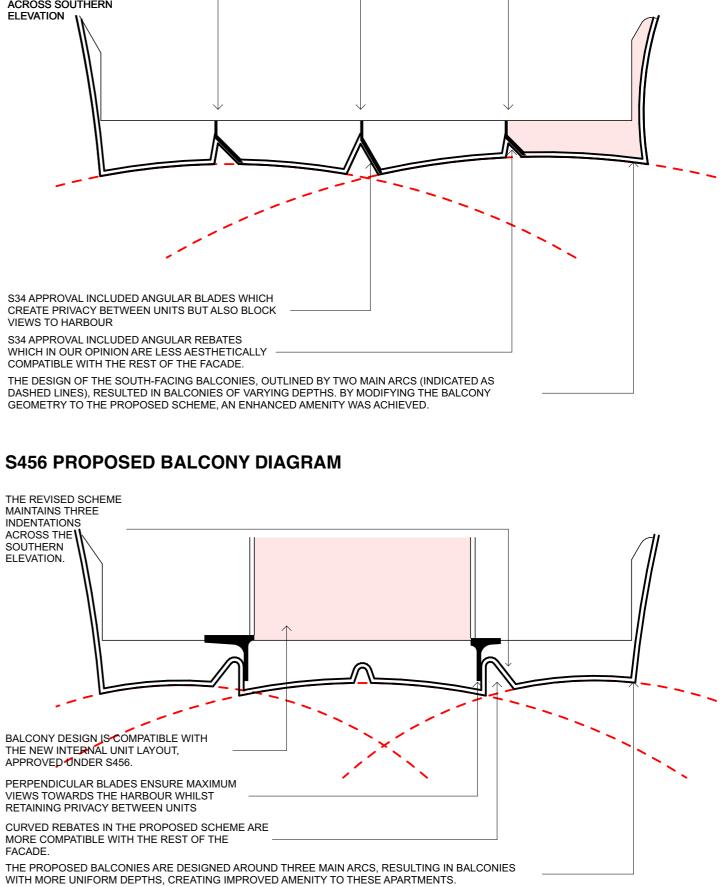


COMPARATIVE PERSPECTIVES 35 RICHARDS AVE SURRY HILLS NSW 2010 Document Set ID: 9868064 Version: 1, Version Date: 17/01/2024

Dwg 3 Rev Nominated Architect B.Meyerson Scale 1:250 15/1/2024 NSW Registration Number 4907 MHNDU


#### **S34 APPROVED PLAN**

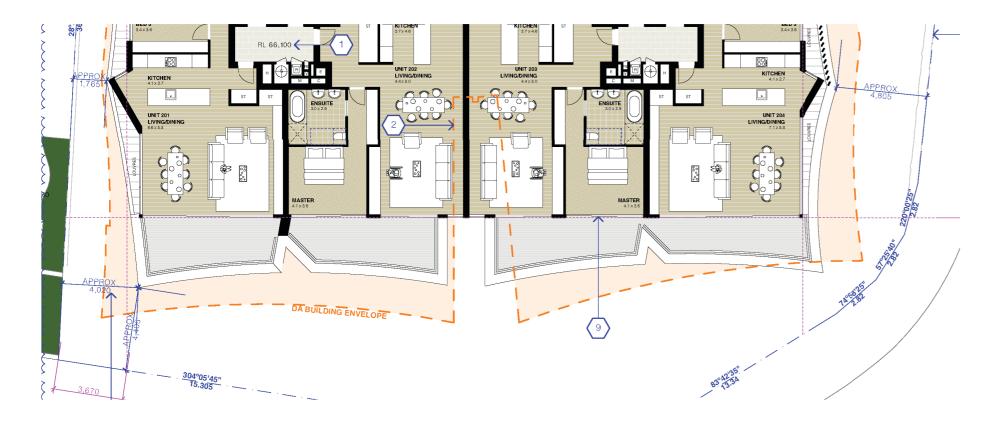

### **S456 H PROPOSED PLAN**

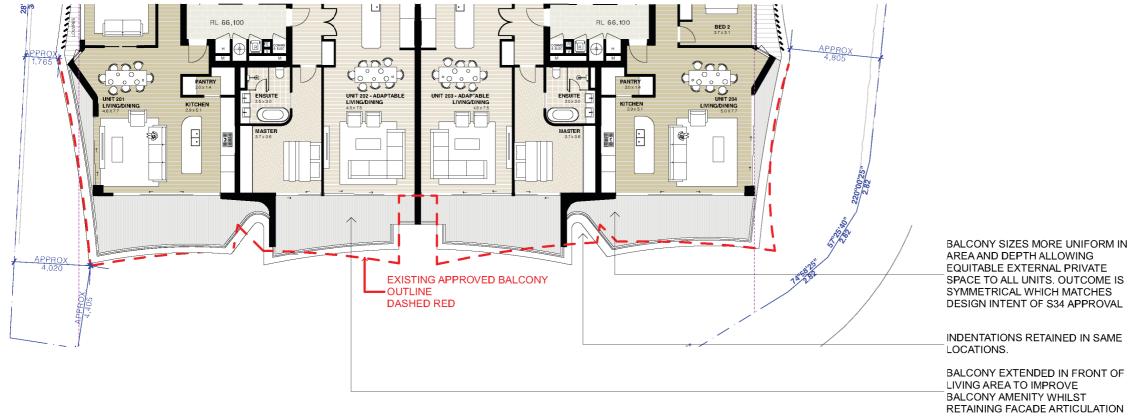

COMPARATIVE PLANS GROUND- LEVEL 2 35 RICHARDS AVE SURRY HILLS NSW 2010 Document Set ID: 9868064 Version: 1, Version Date: 17/01/2024

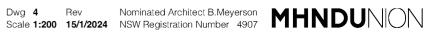


Page 94

#### **S34 APPROVED PLAN**



S456 H PROPOSED PLAN

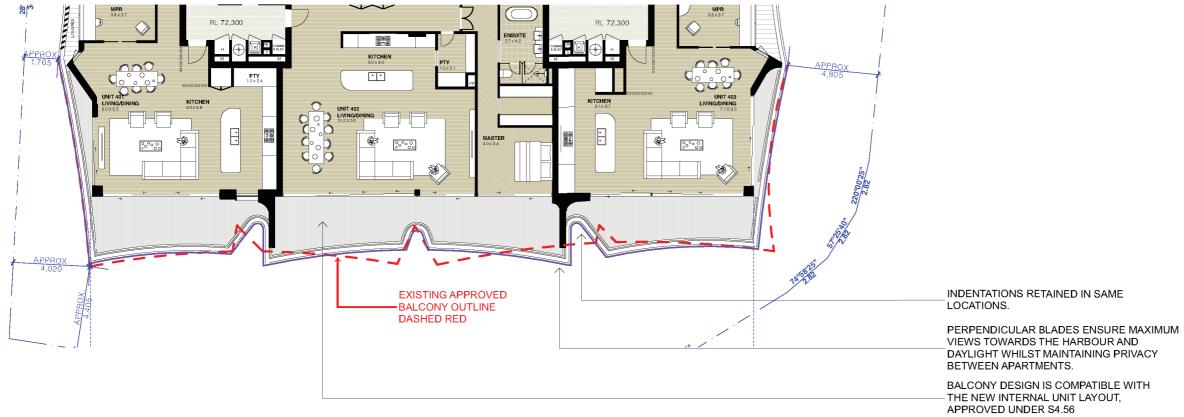

**COMPARATIVE PLANS LEVEL 3- LEVEL 5** 35 RICHARDS AVE SURRY HILLS NSW 2010 Document Set ID: 9868064 Version: 1, Version Date: 17/01/2024

Page 95

S34 PLANS INCLUDED ANGULAR BLADES WHICH -PROVIDE PRIVACY BETWEEN UNITS HOWEVER BLOCK VIEWS OF HARBOUR AND REDUCE DAYLIGHT

